MULTI-FAMILY RESIDENTIAL SITE PLAN "GRAPEVINE RUN"

TAX MAP 175, LOTS 1, 2, & 3

GENERAL LEGEND

100x0 × 100.00

\$ □--

D----

<u>EXISTING</u>	<u>PROPOSED</u>	<u>DESCRIPTION</u>
		PROPERTY LINES
		SETBACK LINES
		CENTERLINE
· · · · · · · · · · · · · · · · · · ·		TREE LINE
	· · · · · · · · · · · · · · · · · · ·	STONEWALL
		FENCE
		SOIL BOUNDARY
		ZONELINE
—100— —	 100	EASEMENT MAJOR CONTOUR
— — <i>98</i> — — —		MINOR CONTOUR
		EDGE OF PAVEMENT
VGC	VGC	VERTICAL GRANITE CL
SGC	SGC	SLOPE GRANITE CURE
x	——х——	SILT FENCE
D		DRAINAGE LINE
s	———— S ———	SEWER LINE
—— FM———	FM	SEWER FORCE MAIN
G	——— G ———	GAS LINE
	w	WATER LINE

DECODIDATION

CURB SPOT GRADE

BENCHMARK (TBM) DOUBLE POST SIGN SINGLE POST SIGN

FAILED TEST PIT

UTILITY POLE

REDUCER

STABILIZED CONSTRUCTION **ENTRANCE**

SNOW STORAGE RETAINING WALL

212, 214, & 216 WOODBURY AVE., PORTSMOUTH, NH

STONE/GRANITE BOUND

PAVEMENT SPOT GRADE

TEST PIT

TREES AND BUSHES LIGHT POLES

SEWER MANHOLE HYDRANT WATER GATE WATER SHUT OFF

SINGLE GRATE CATCH BASIN DOUBLE GRATE CATCH BASIN

DRAINAGE FLOW DIRECTION RIPRAP

CONCRETE

CIVIL ENGINEER / SURVEYOR JONES & BEACH ENGINEERS, INC.

85 PORTSMOUTH AVENUE PO BOX 219 STRATHAM, NH 03885 (603) 772-4746 CONTACT: JOSEPH CORONATI EMAIL: JCORONATI@JONESANDBEACH.COM

LIGHTING CONSULTANT

CHARRON, INC. P.O BOX 4550 MANCHESTER, NH 03108 (603) 945-3500 CONTACT: DANIEL HEBERT EMAIL: DHEBERT@CHARRONINC.COM

SOILS CONSULTANT

GOVE ENVIRONMENTAL SERVICES, INC. 8 CONTINENTAL DR., BLDG 2, UNIT H EXETER, NH 03833-7507 (603) 418-7260 CONTACT: JAMES GOVE EMAIL: JGOVE@GESINC.BIZ

LANDSCAPE DESIGNER

LOCUS MAP

SCALE 1" = 500

LM LAND DESIGN, LLC 11 SOUTH ROAD BRENTWOOD, NH 03833 (603) 770-7728 CONTACT: LISE MCNAUGHTON

WATER

CITY OF PORTMOUTH DEPARTMENT OF PUBLIC WORKS WATER DIVISION 680 PEVERLY HILL ROAD PORTSMOUTH, NH 03801 CONTACT: BRIAN GOETZ, P.E. (603) 427-1530

SEWER

CITY OF PORTMOUTH DEPARTMENT OF PUBLIC WORKS SEWER DIVISION 680 PEVERLY HILL ROAD PORTSMOUTH, NH 03801 CONTACT: ZACHARY CRONIN (603) 766-1421

Stratham, NH 03885

SHEET INDEX

COVER SHEET

EXISTING CONDITIONS PLAN

DEMOLITION PLAN

LOT LINE ADJUSTMENT PLAN

SITE PLAN

GRADING AND DRAINAGE PLAN

UTILITY PLAN

PLAN AND ROAD PROFILE

PLAN AND SEWER PROFILE

LIGHTING PLAN

LANDSCAPE PLAN

DETAIL SHEETS

EROSION AND SEDIMENT CONTROL DETAILS

SLOPE CROSS SECTIONS

TRUCK TURNING PLAN

HIGHWAY ACCESS PLAN

OFFSITE DRAINAGE PLAN

ELECTRIC EVERSOURCE

1700 LAFAYETTE ROAD PORTSMOUTH, NH 03801 (603) 634-3029 CONTACT: CASEY MACDONALD **TELEPHONE**

FAIRPOINT COMMUNICATIONS 1575 GREENLAND ROAD GREENLAND, NH 03840

(800) 427-5525 **CONTACT: JOE CONSIDINE**

CABLE TV

(603) 679-5695

COMCAST COMMUNICATION CORPORATION 334-B CALEF HIGHWAY EPPING, NH 03042-2325

FAX: 603-772-0227

E-MAIL: JBE@JONESANDBEACH.COM

CITY OF PORTSMOUTH TAX MAP 175, LOTS 1, 2, & 3

PROJECT PARCEL

APPLICANT TUCK REALTY CORP. ATTN: TURNER PORTER 149 EPPING RD., SUITE 2A EXETER, NH 03833


TOTAL LOT AREA 80,484 SQ. FT. 1.85 ACRES

APPROVED - PORTSMOUTH, NH PLANNING BOARD

DATE:

Design: JAC Draft: DJM Checked: JAC | Scale: AS NOTED | Project No.: 21254 Drawing Name: 21254-PLAN.dwg

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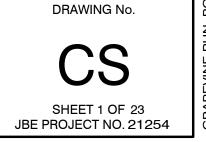


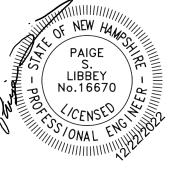
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3	9/14/22	ISSUED TO DEPARTMENT OF PUBLIC WORKS	DJM
REV.	DATE	REVISION	BY

Designed and Produced in NH Jones & Beach Engineers, Inc. 85 Portsmouth Ave. Civil Engineering Services 603-772-4746

COVER SHEET Plan Name: "GRAPEVINE RUN" Project:

212, 214, & 216 WOODBURY AVE. PORTSMOUTH, NH 03801 LOT 1: BK 4708 PG 979 LOT 2: BK 4582 PG 888 FREDERICK J. BAILEY III & JOYCE S. NELSON Owner of Record: 4 SHORE RD., WOLFEBORO, NH 03894 LOT 3: BK 3919 PG 1345



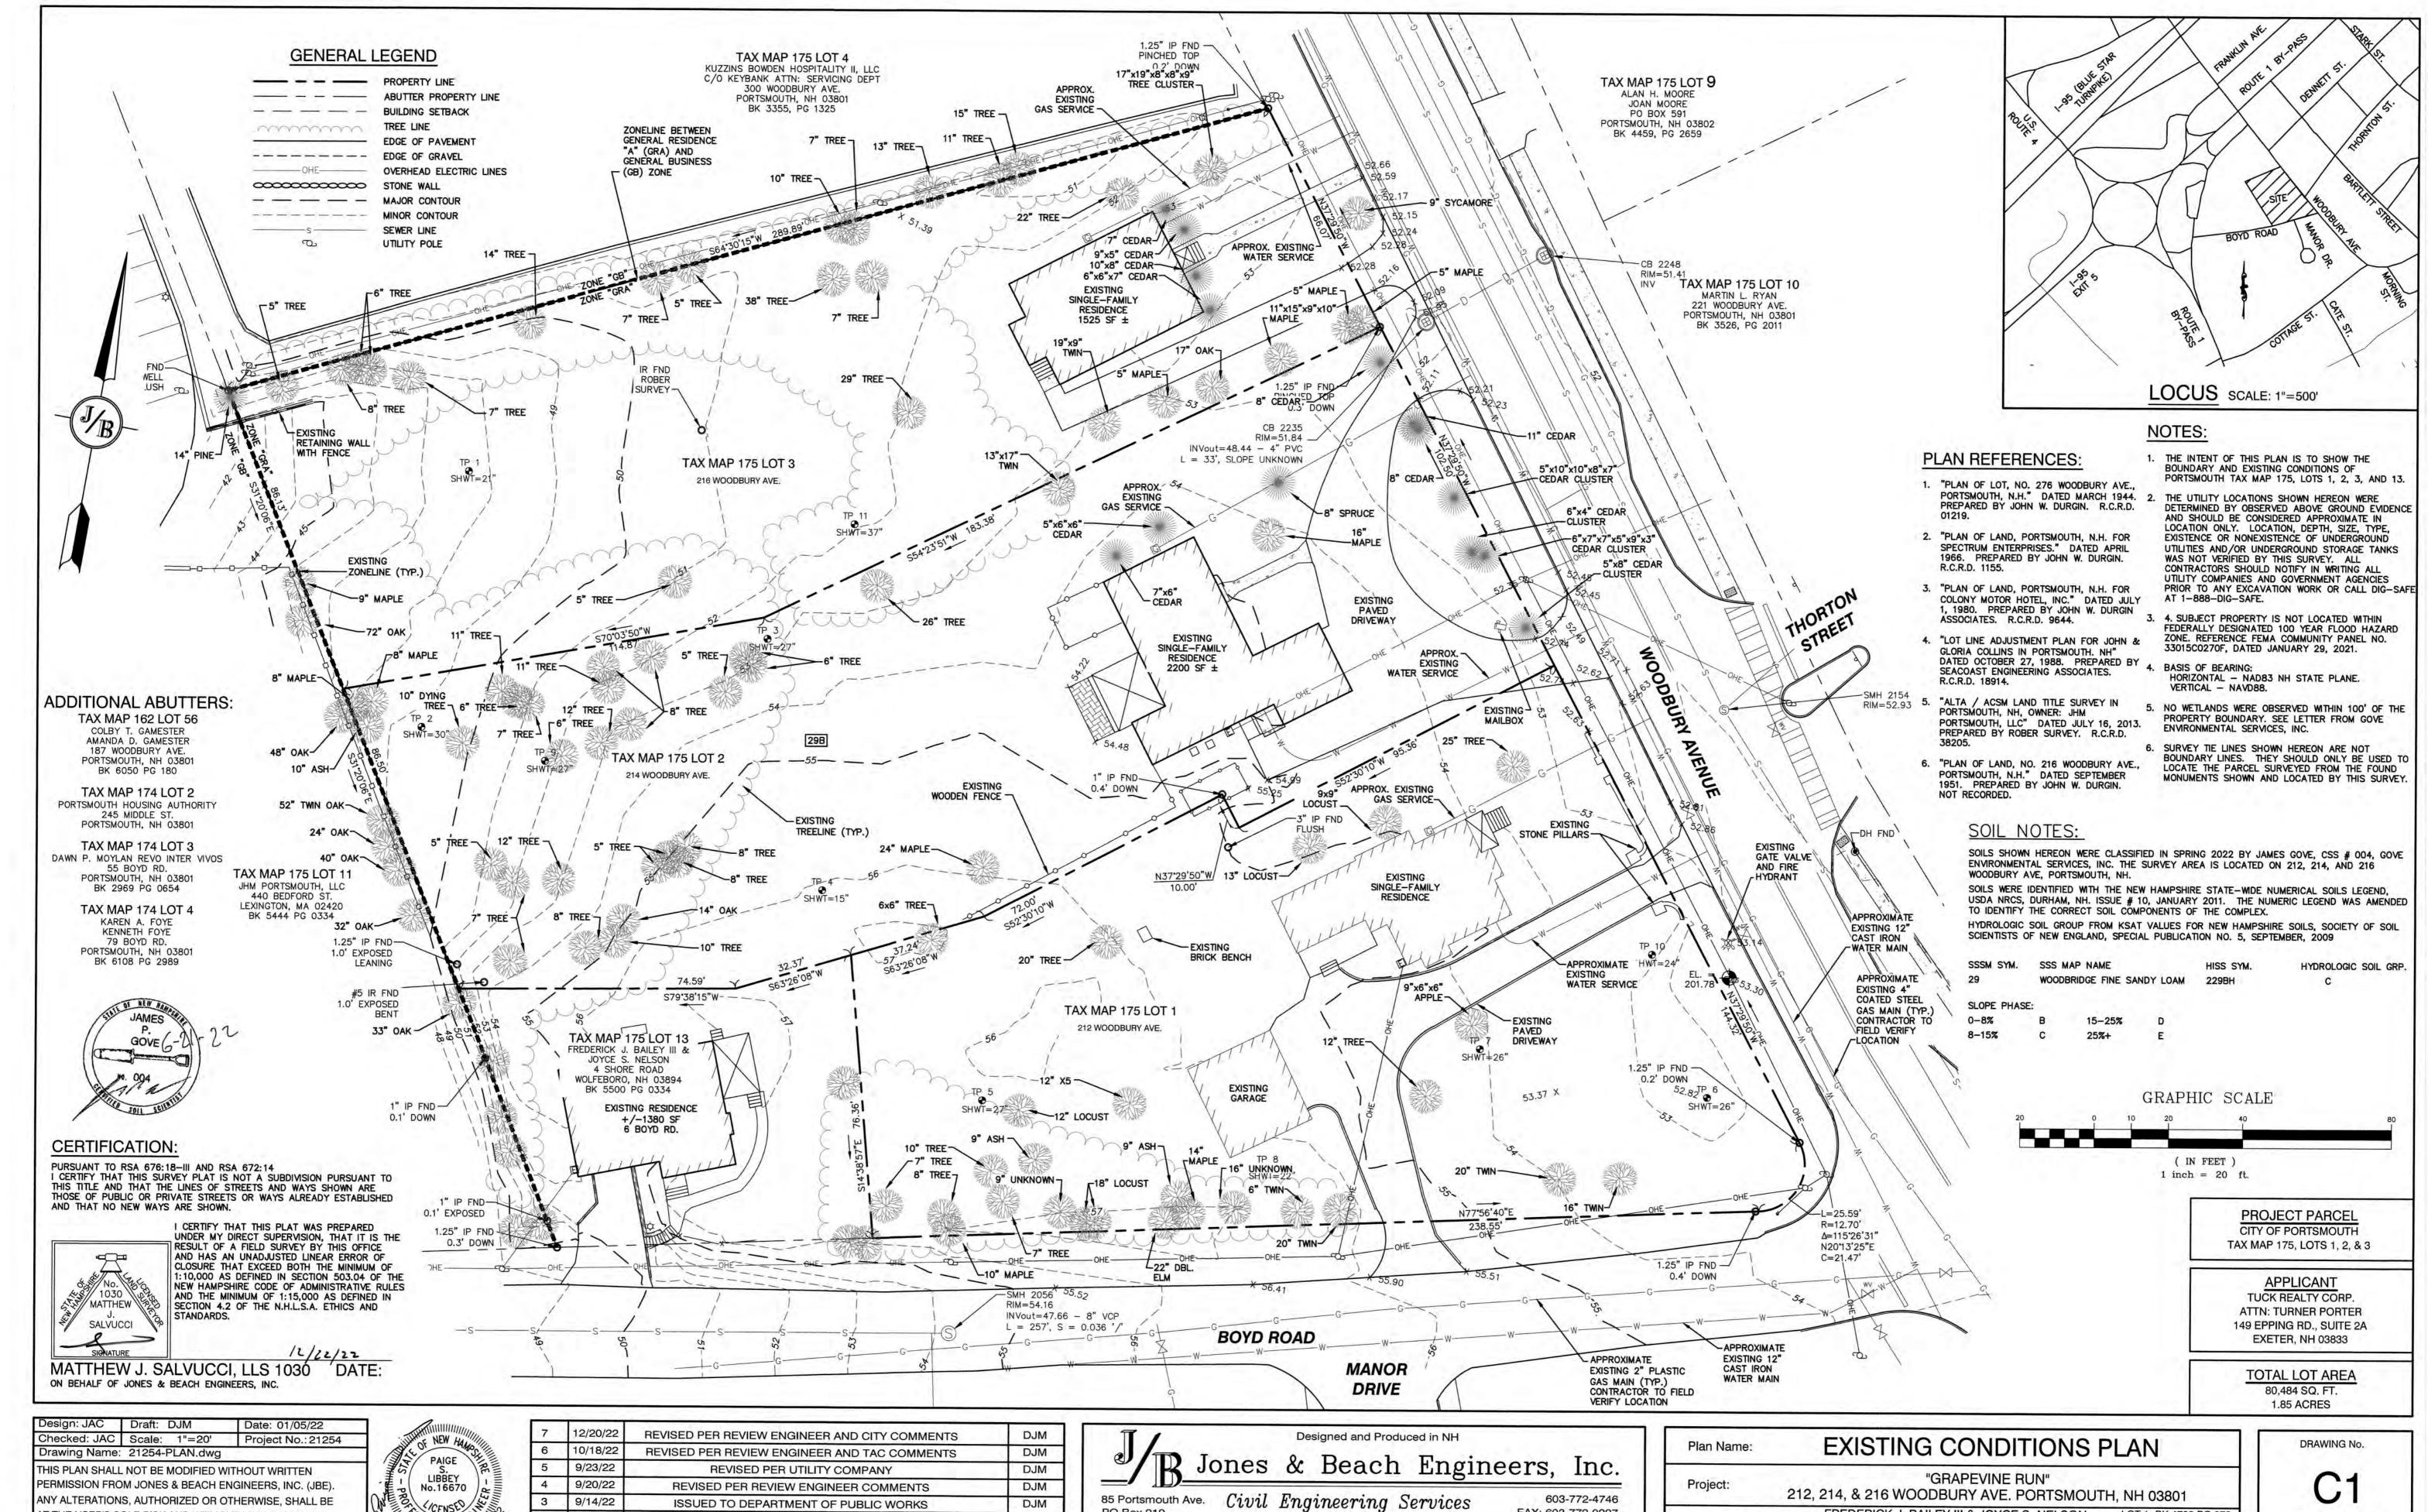

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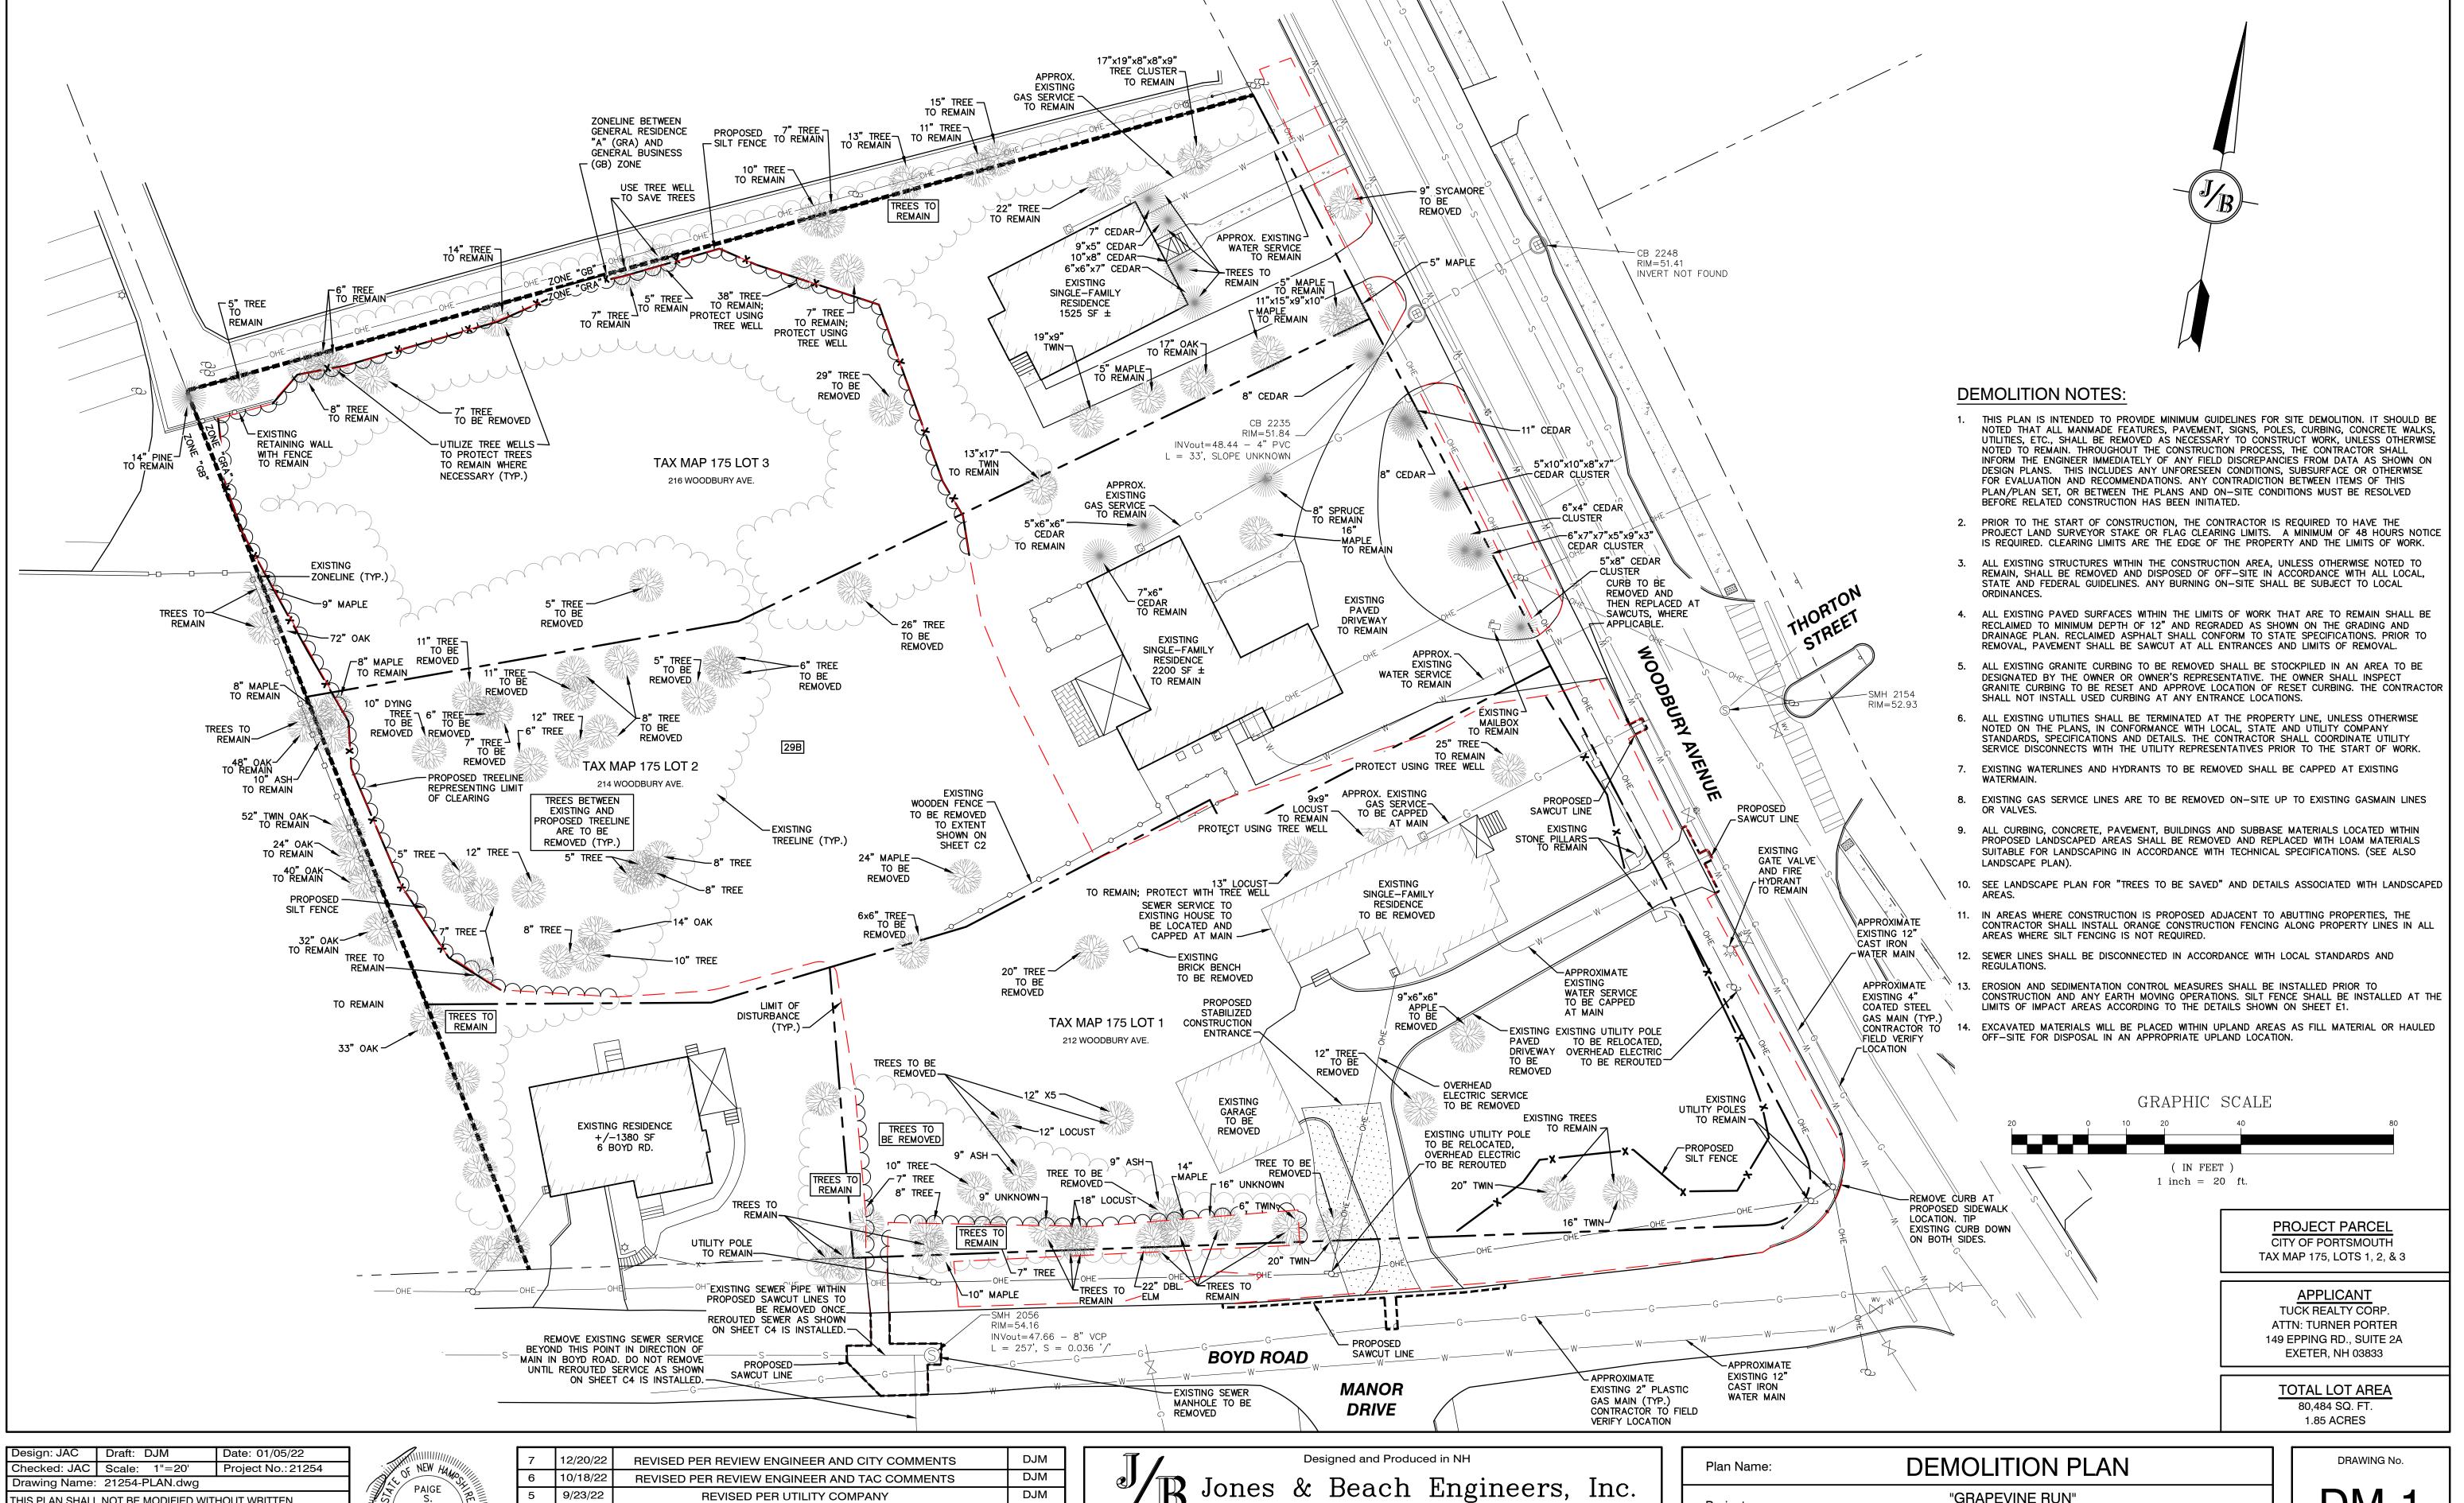
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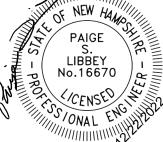
FREDERICK J. BAILEY III & JOYCE S. NELSON LOT 1: BK 4708 PG 979 LOT 2: BK 4582 PG 888 Owner of Record:

4 SHORE RD., WOLFEBORO, NH 03894

SHEET 2 OF 23 JBE PROJECT NO. 21254



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"GRAPEVINE RUN" Project: 212, 214, & 216 WOODBURY AVE. PORTSMOUTH, NH 03801


Owner of Record:

FREDERICK J. BAILEY III & JOYCE S. NELSON

4 SHORE RD., WOLFEBORO, NH 03894

SHEET 3 OF 23 JBE PROJECT NO. 21254

LOT 1: BK 4708 PG 979 LOT 2: BK 4582 PG 888

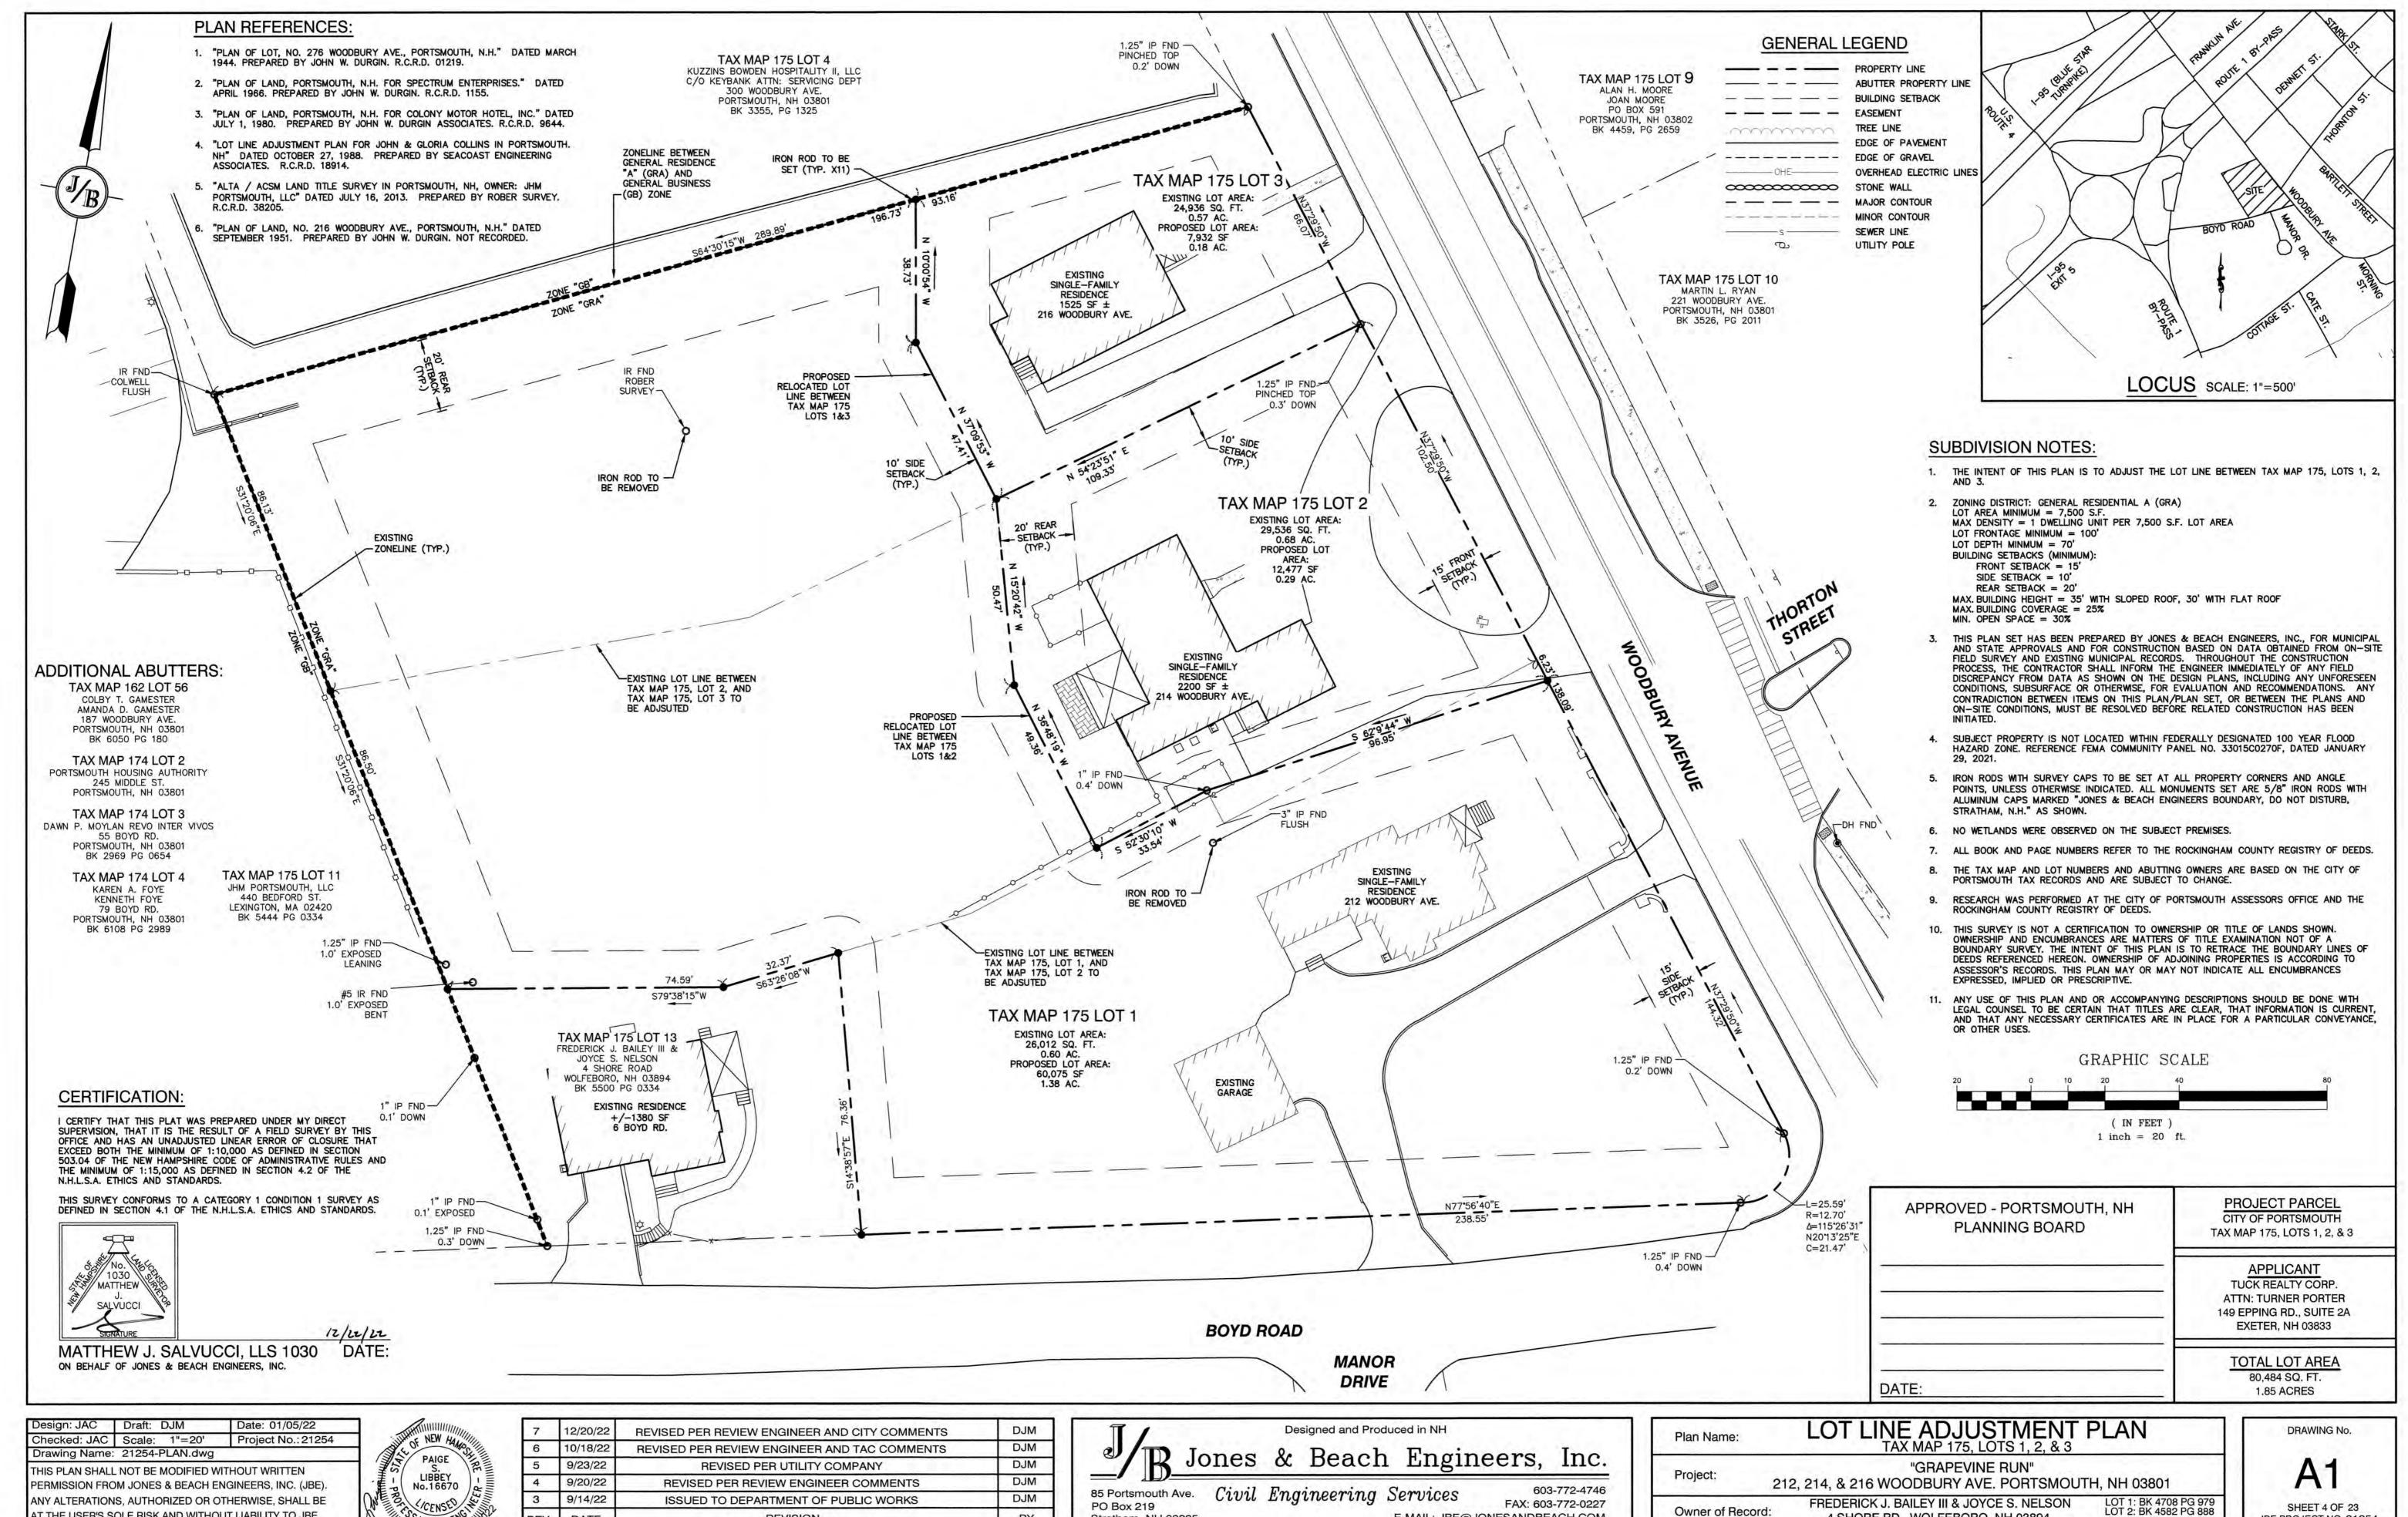

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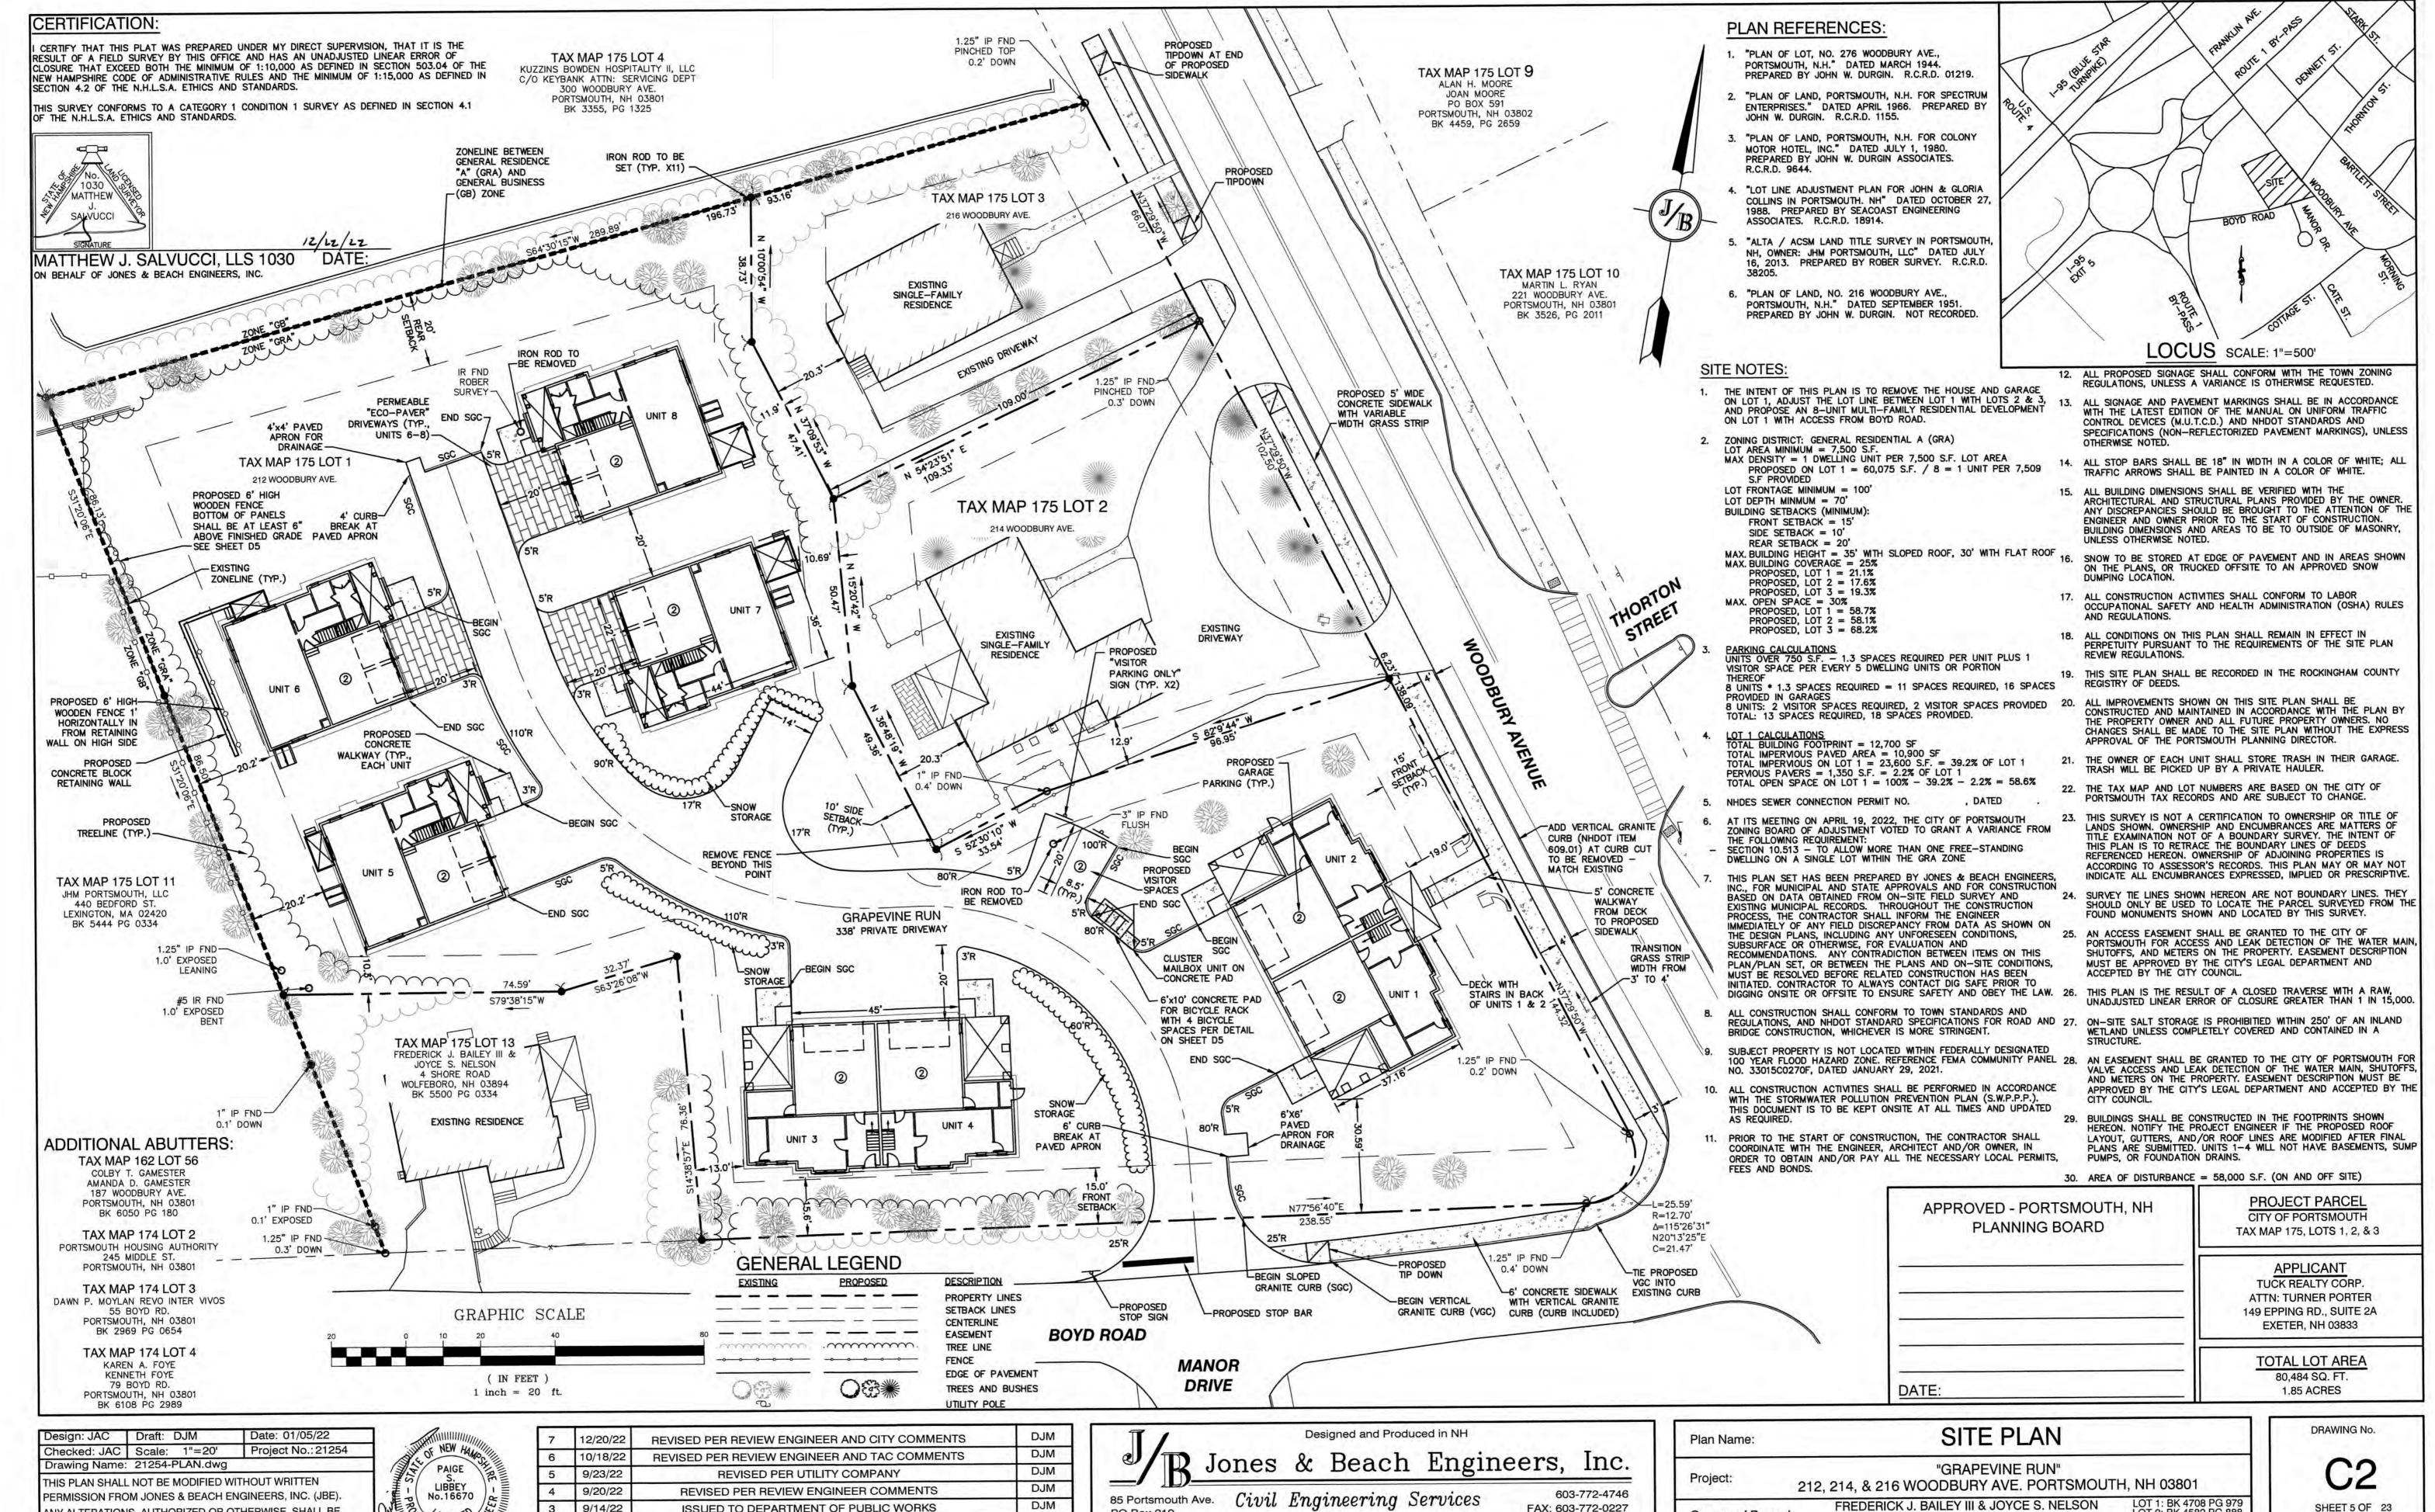
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SHEET 4 OF 23 JBE PROJECT NO. 21254




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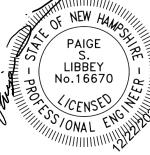
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JBE PROJECT NO. 21254



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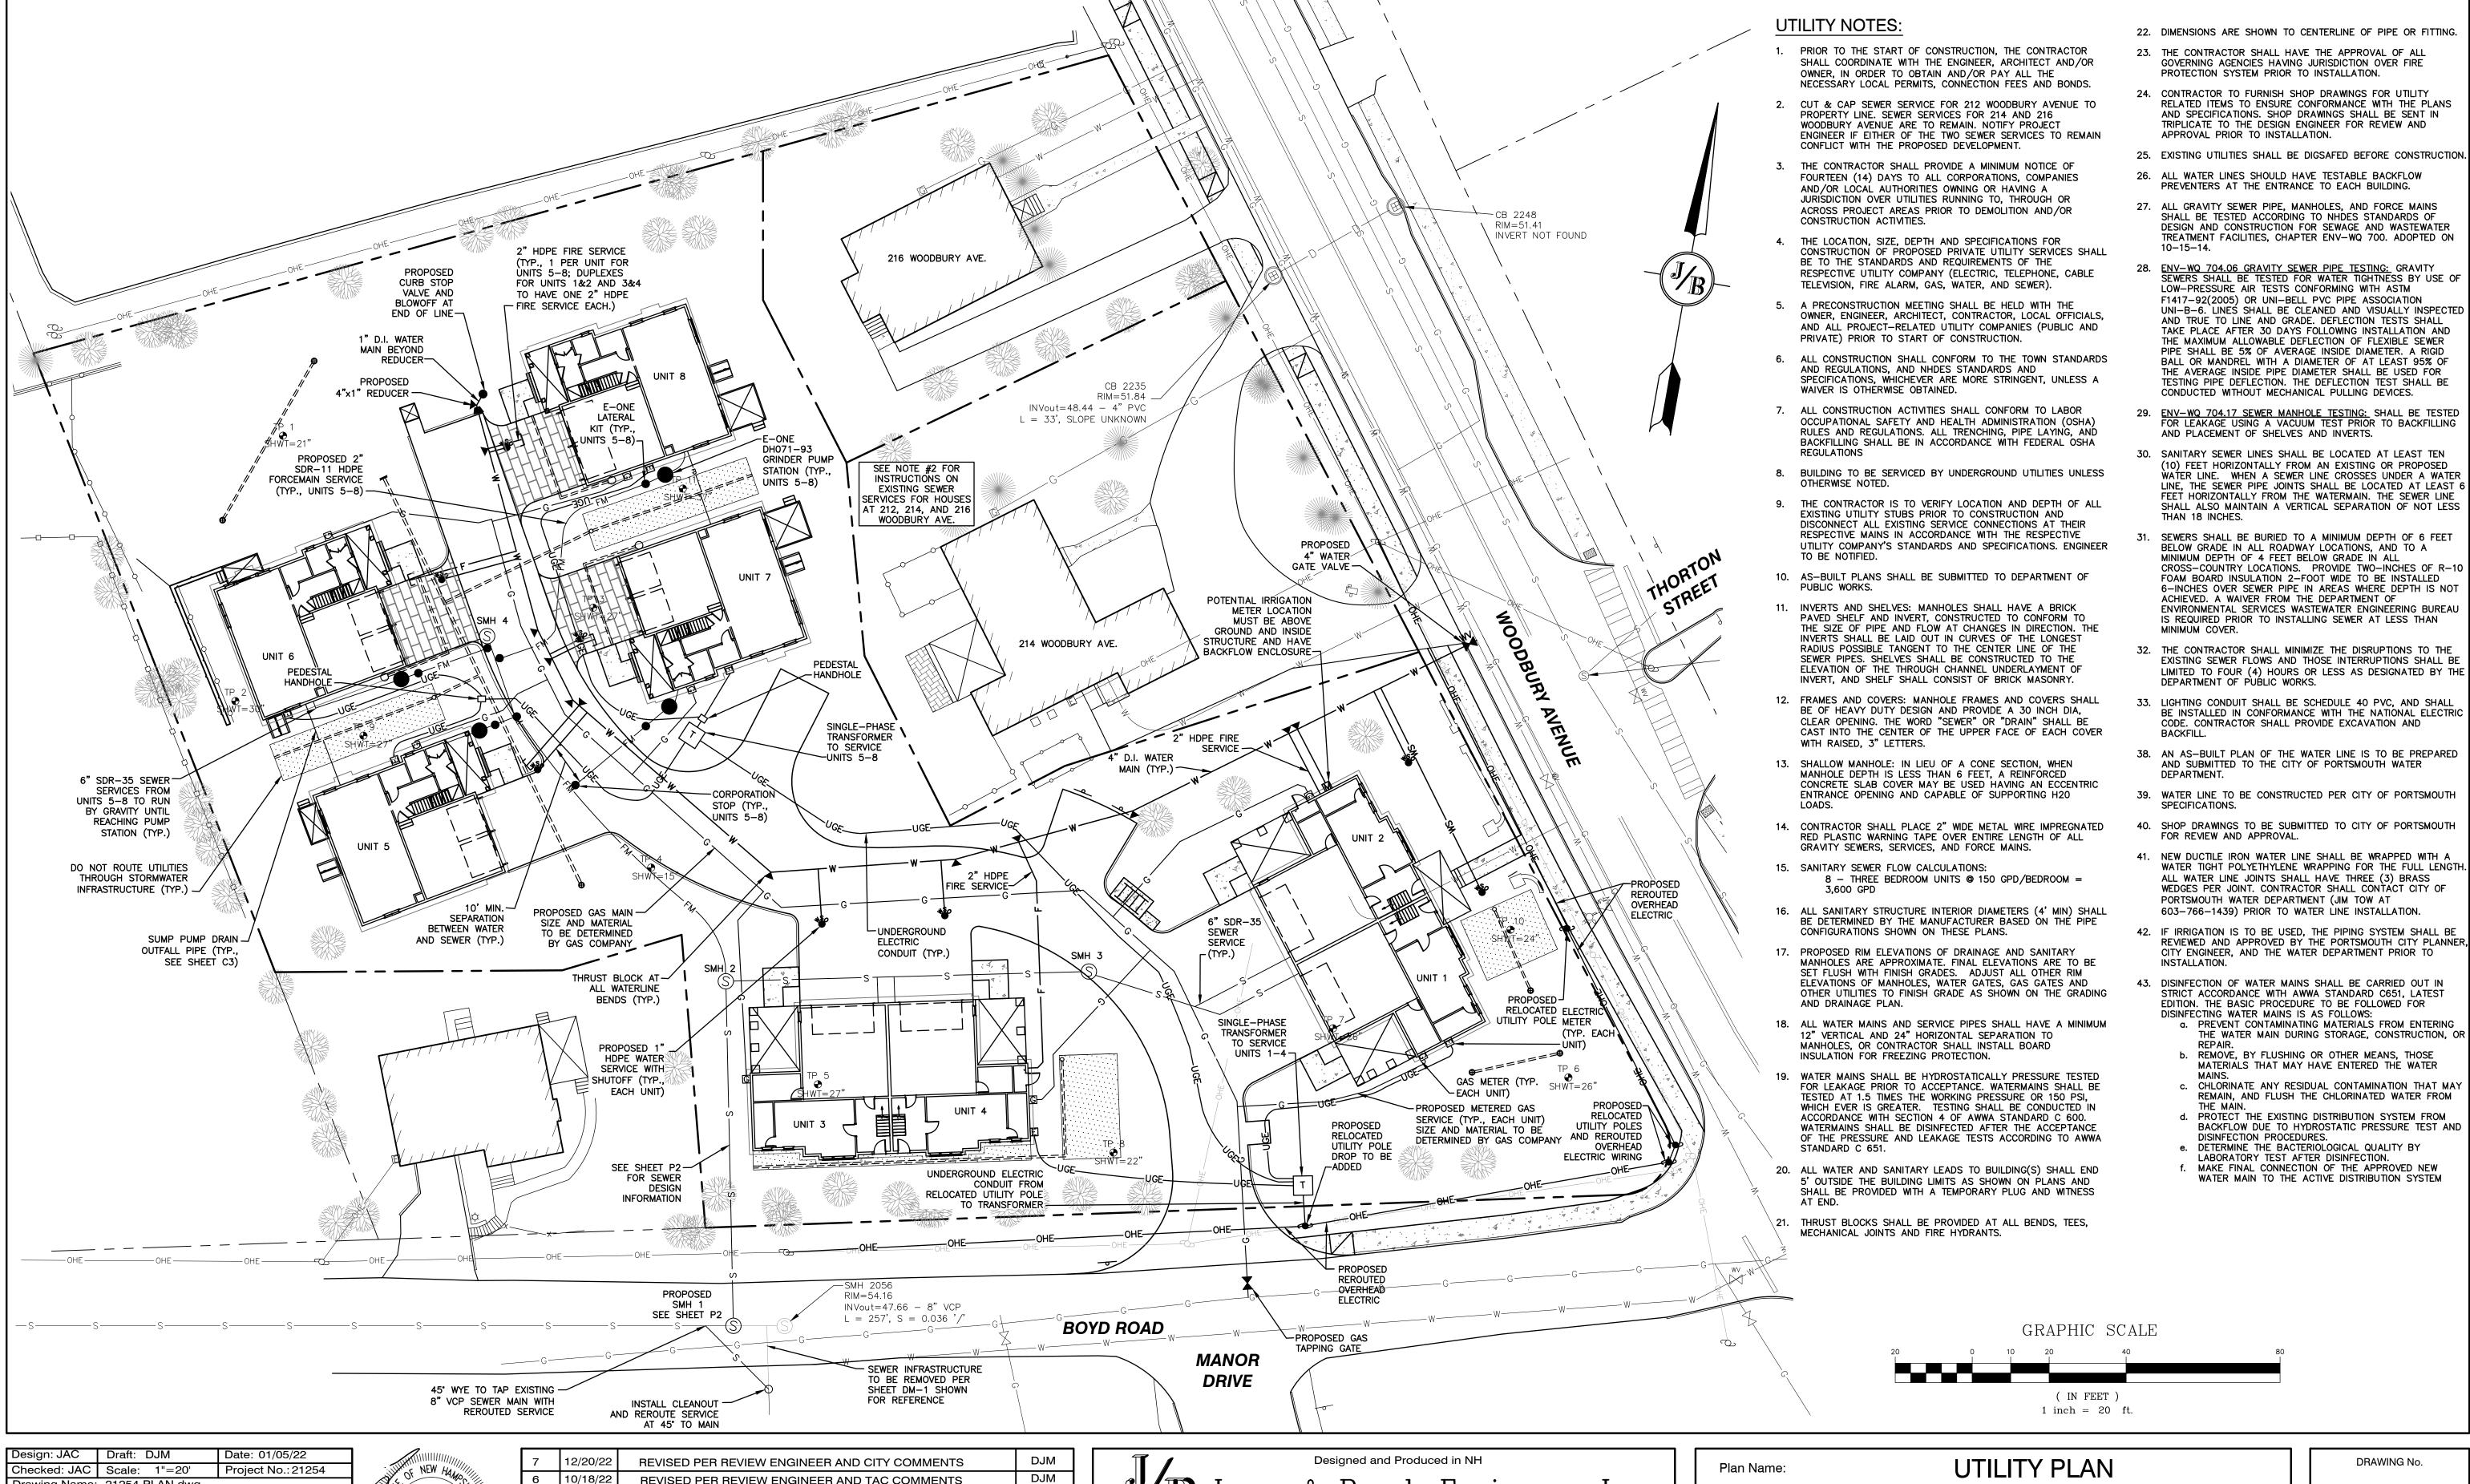
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"GRAPEVINE RUN"


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SHEET 6 OF 23 JBE PROJECT NO. 21254

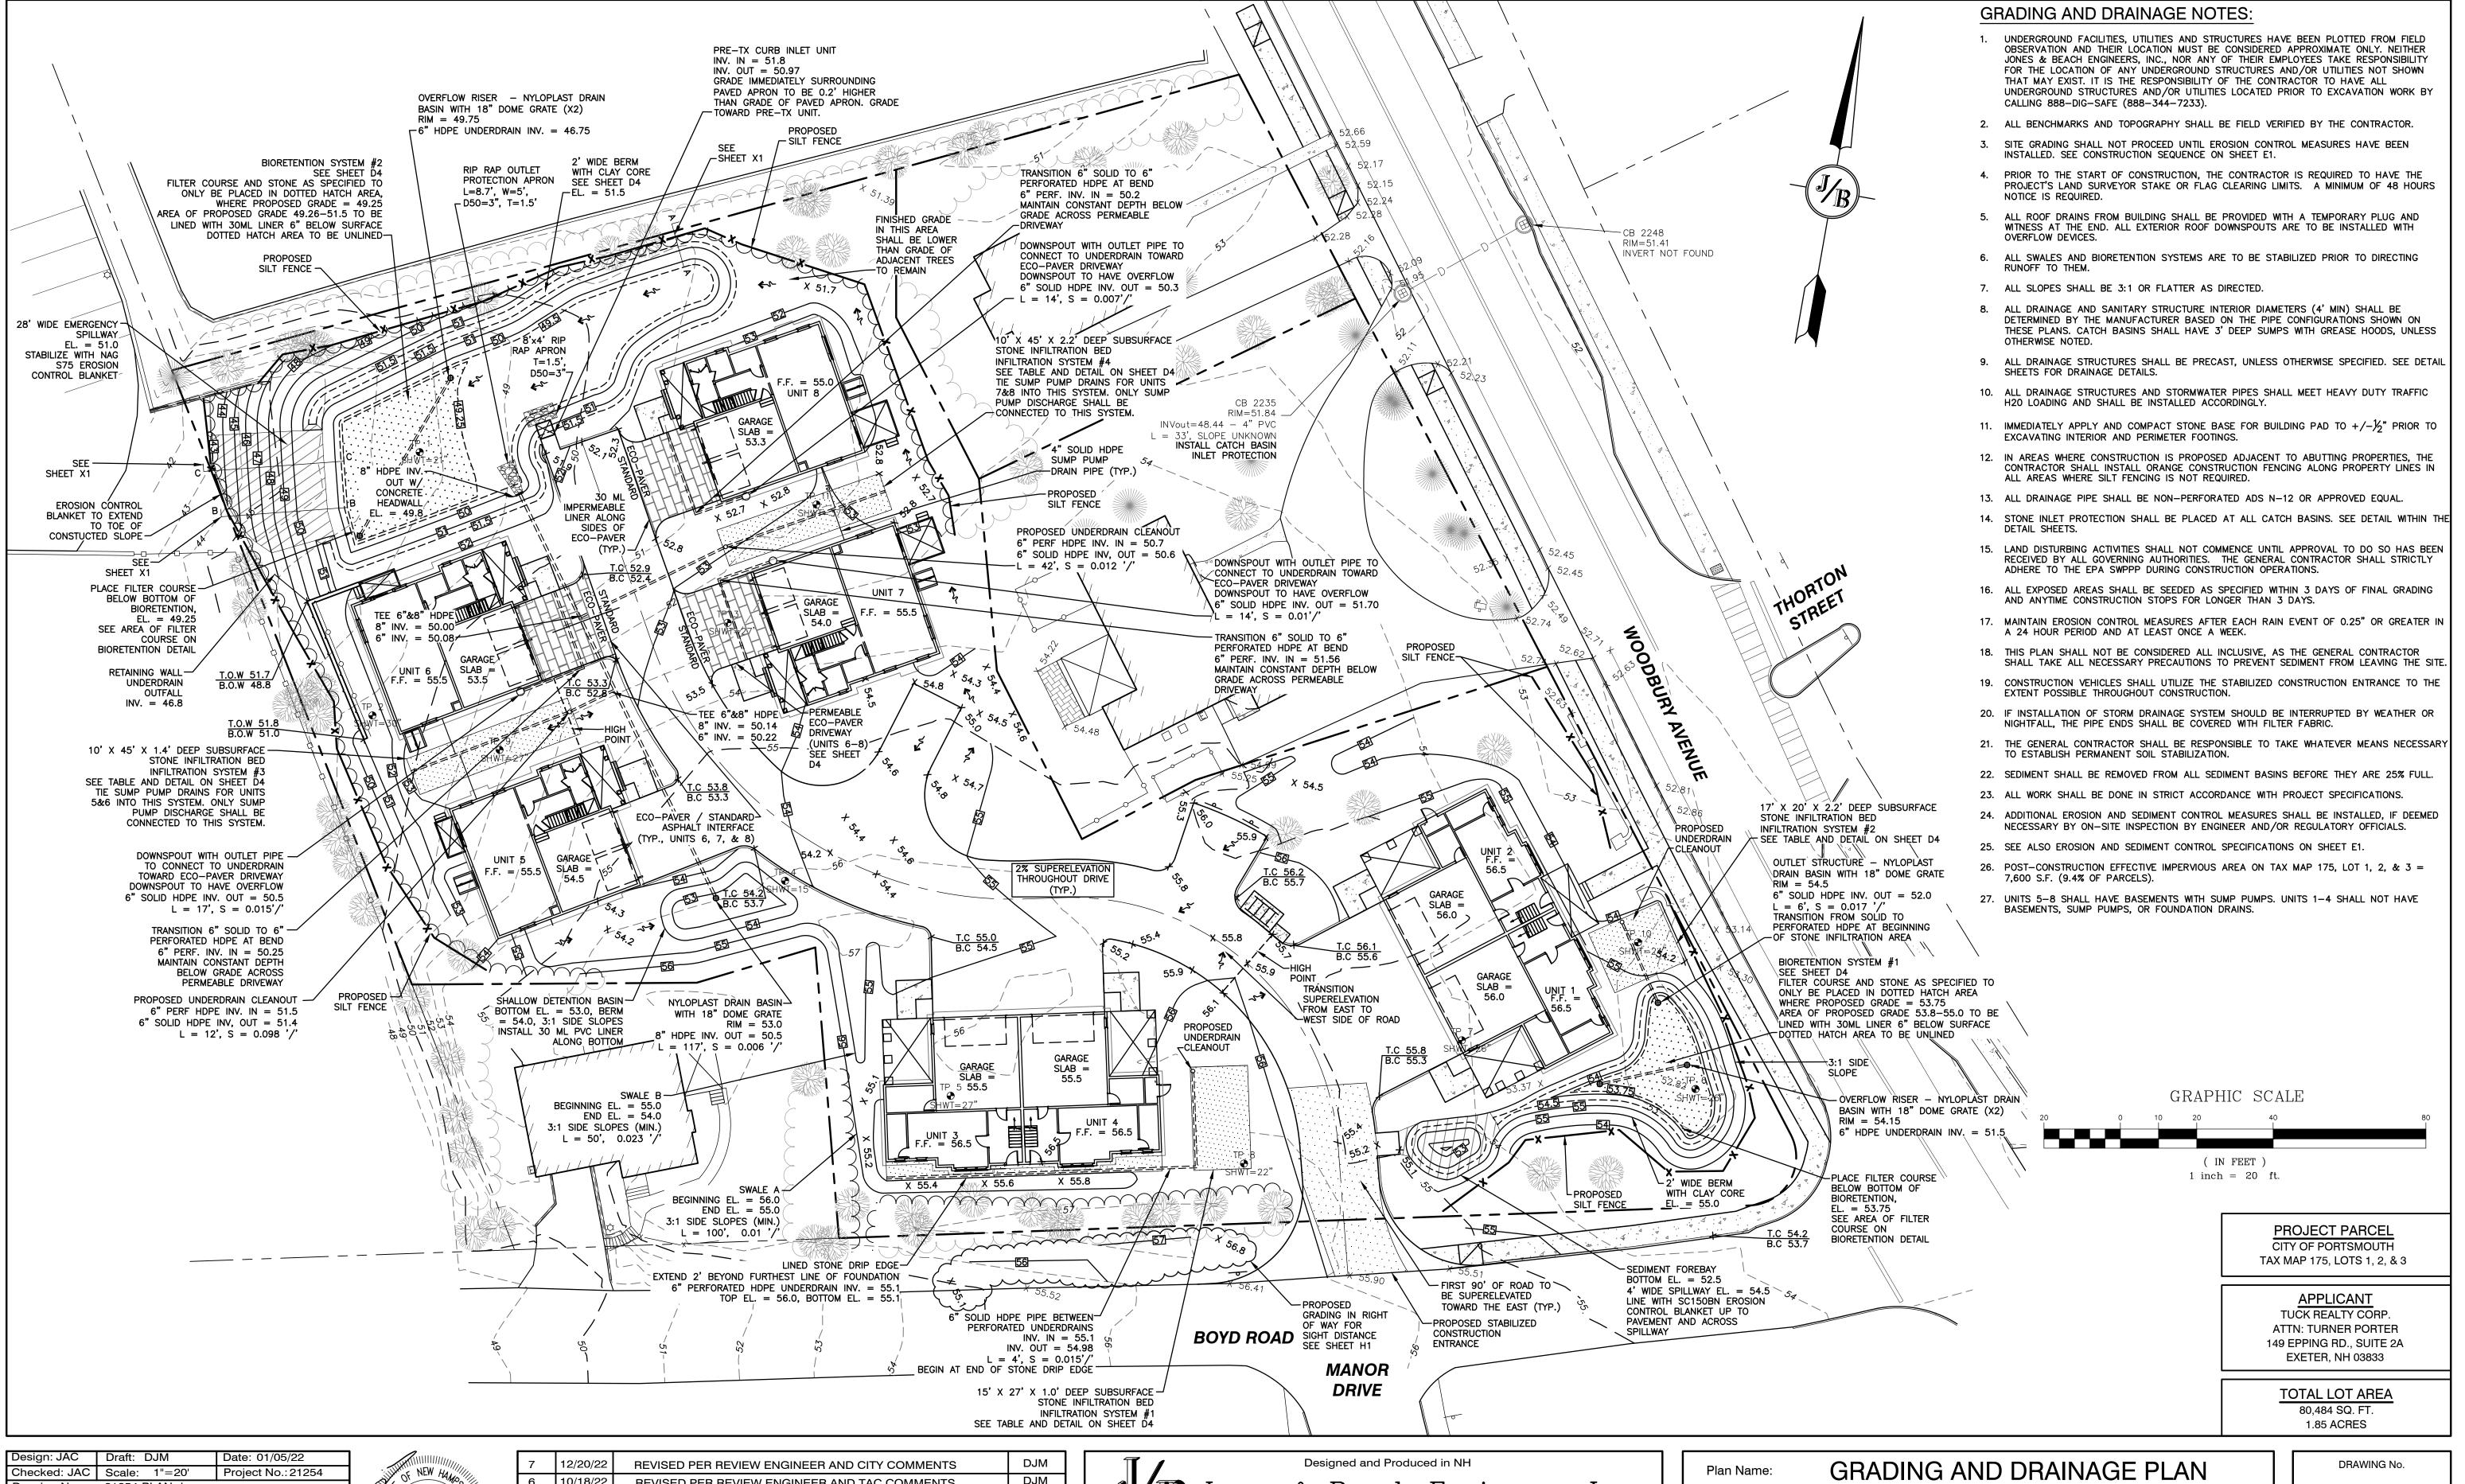

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Project:

"GRAPEVINE RUN"


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SHEET 7 OF 23 JBE PROJECT NO. 21254

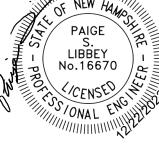

Design: JAC	Draft: DJM	Date: 01/05/22
Checked: JAC	Scale: 1"=20'	Project No.: 21254
Drawing Name:	21254-PLAN.dwg	

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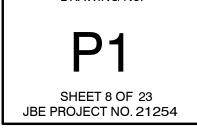



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Plan Name:	PLAN AND ROAD PROFILE	
Droject	"GRAPEVINE RUN"	

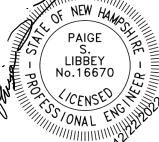Project: 212, 214, & 216 WOODBURY AVE. PORTSMOUTH, NH 03801 LOT 1: BK 4708 PG 979 LOT 2: BK 4582 PG 888 FREDERICK J. BAILEY III & JOYCE S. NELSON Owner of Record:

4 SHORE RD., WOLFEBORO, NH 03894



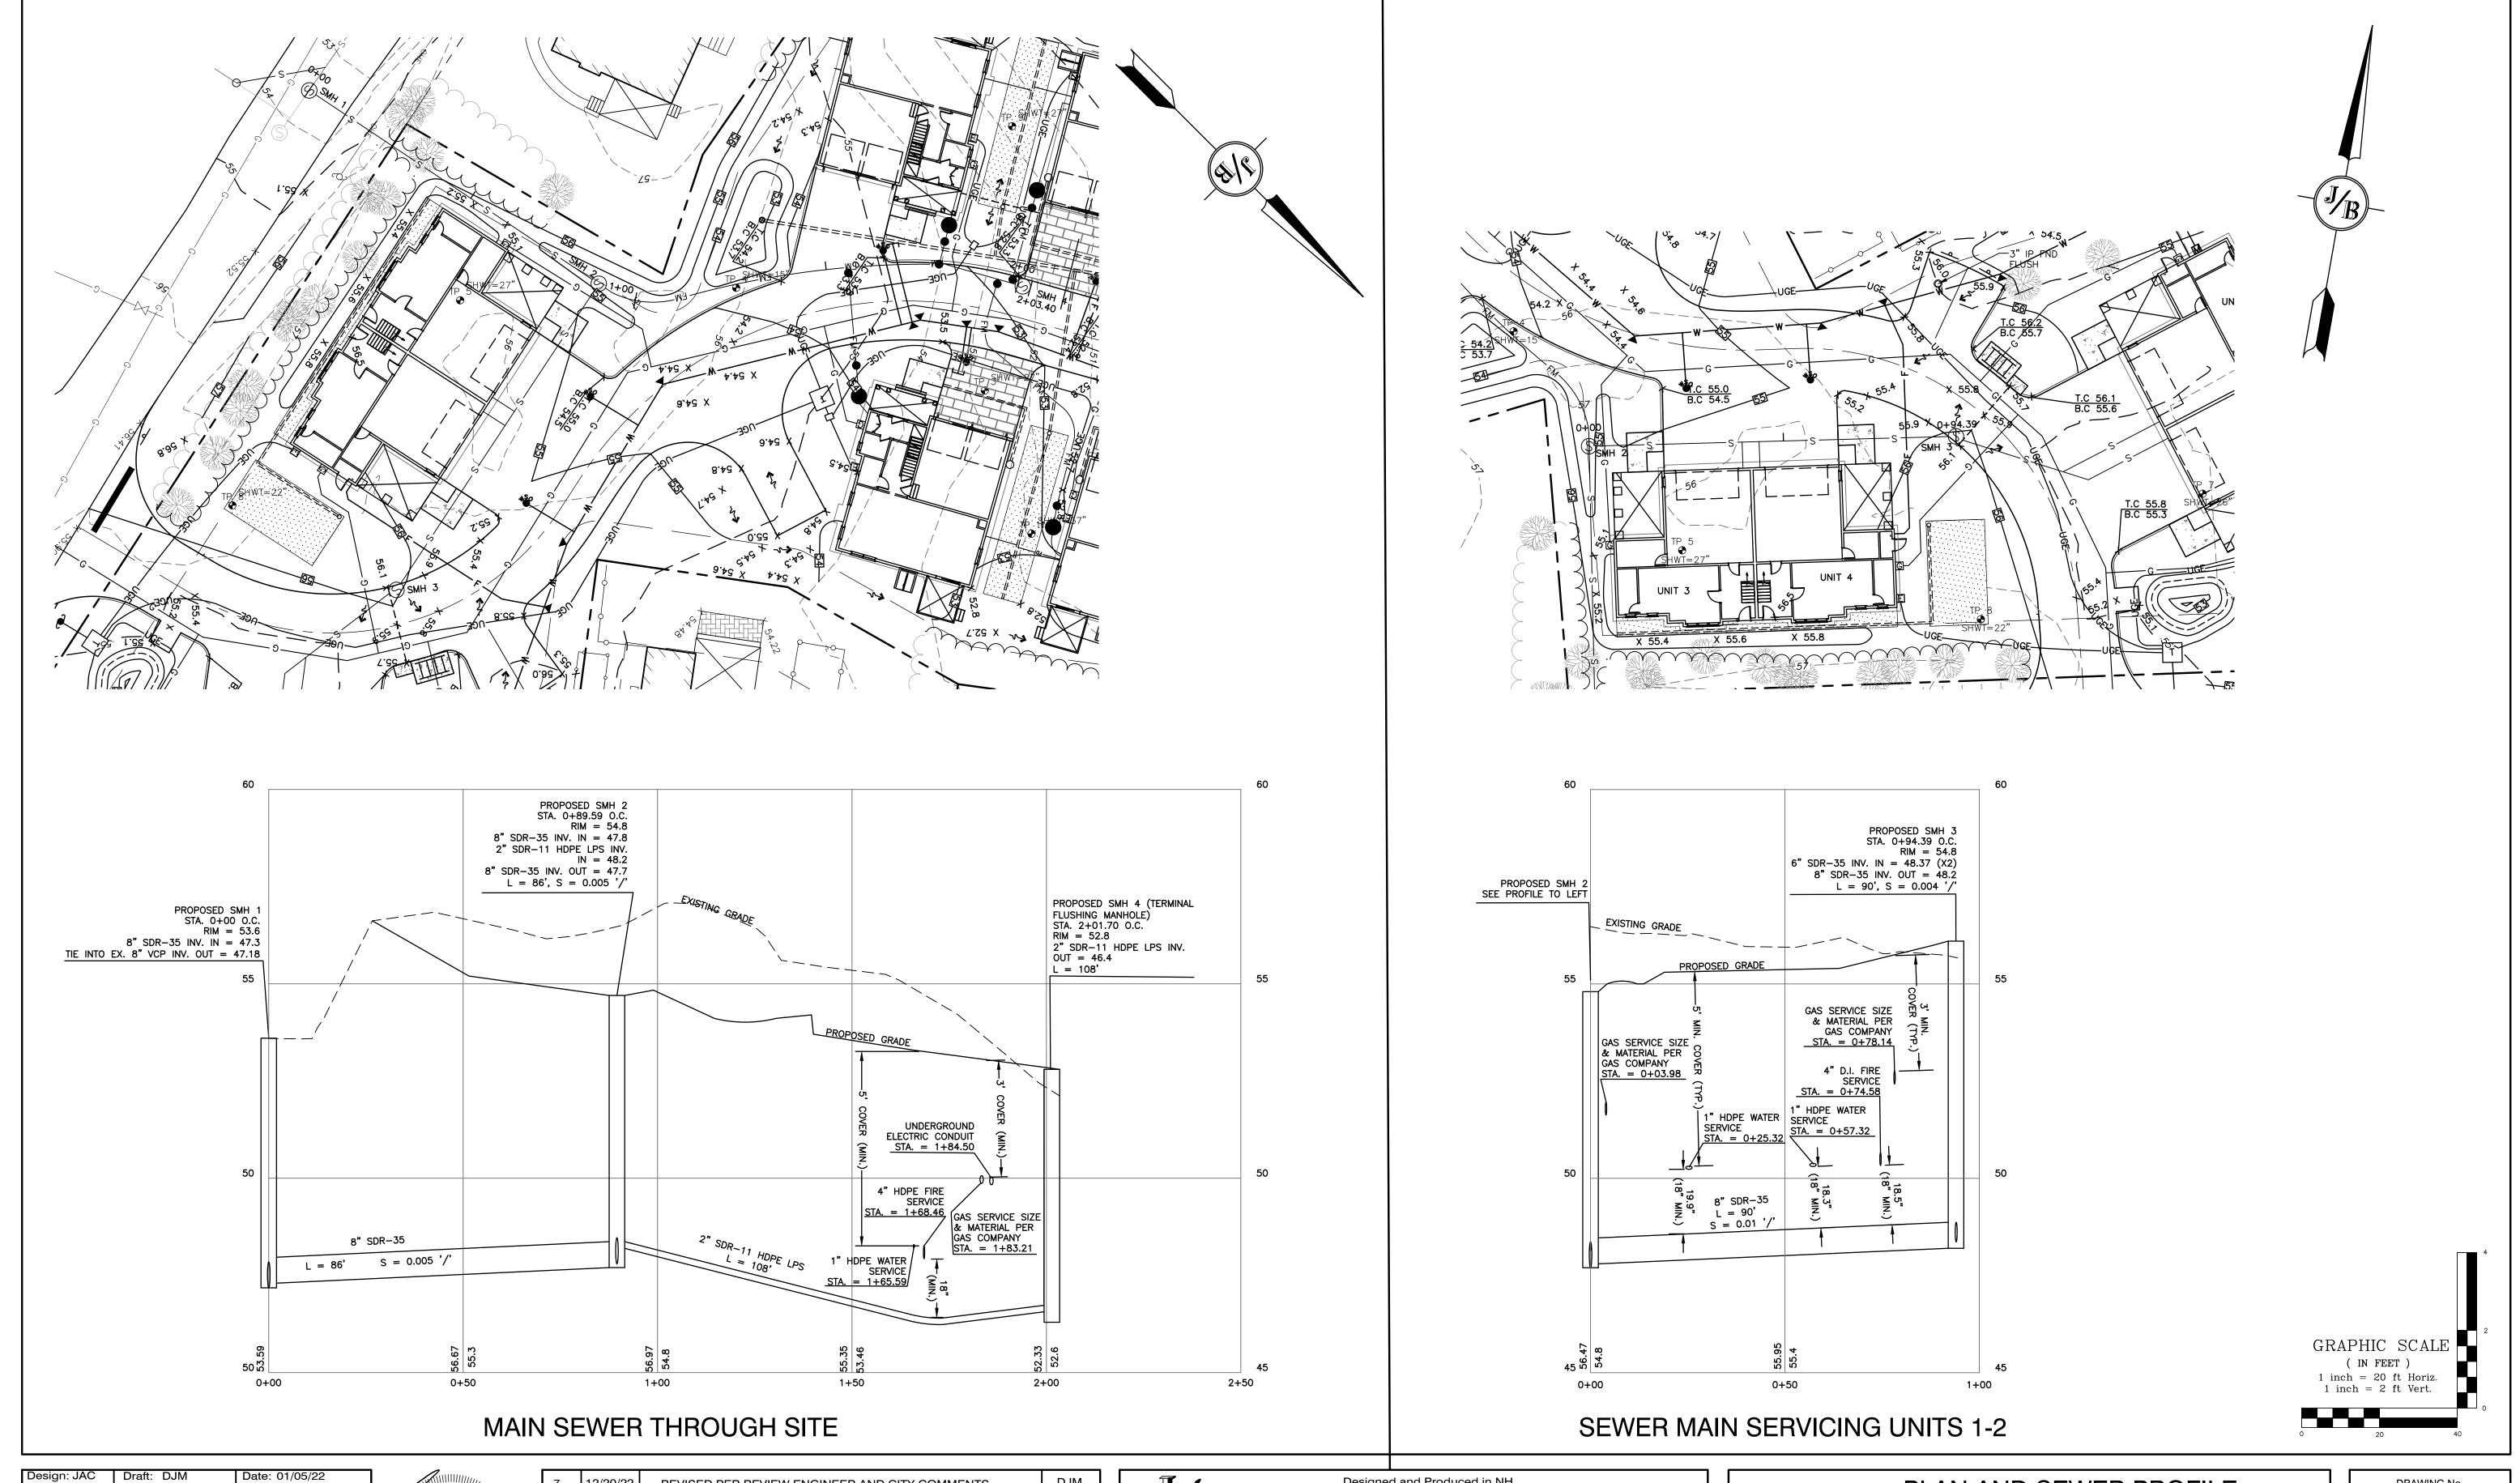

Checked: JAC Scale: 1"=20' Project No.: 21254 Drawing Name: 21254-PLAN.dwg THIS PLAN SHALL NOT BE MODIFIED WITHOUT WRITTEN PERMISSION FROM JONES & BEACH ENGINEERS, INC. (JBE). ANY ALTERATIONS, AUTHORIZED OR OTHERWISE, SHALL BE

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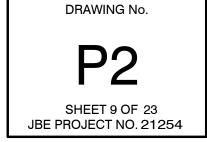



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Plan Name:	PLAN AND SEWER PRO	FILE	
Project:	"GRAPEVINE RUN" 212, 214, & 216 WOODBURY AVE. PORTSMOUTH, NH 03801		
Owner of Record:	FREDERICK J. BAILEY III & JOYCE S. NELSON 4 SHORE RD., WOLFEBORO, NH 03894	LOT 1: BK 4708 PG 979 LOT 2: BK 4582 PG 888 LOT 3: BK 3919 PG 1345	





LANDSCAPE NOTES:

- THE CONTRACTOR SHALL LOCATE AND VERIFY THE EXISTENCE OF ALL UTILITIES PRIOR TO STARTING WORK.
- 2. THE CONTRACTOR SHALL SUPPLY ALL PLANT MATERIALS IN QUANTITIES SUFFICIENT TO COMPLETE THE PLANTINGS SHOWN ON THE DRAWINGS.
- 3. ALL MATERIAL SHALL CONFORM TO THE GUIDELINES ESTABLISHED BY THE CURRENT AMERICAN STANDARD FOR NURSERY STOCK PUBLISHED BY THE AMERICAN ASSOCIATION OF NURSERYMEN.
- 4. PLANTS SHALL BE SUBJECT TO INSPECTION AND APPROVAL AT THE PLACE OF GROWTH, UPON DELIVERY OR AT THE JOB SITE WHILE WORK IS ON-GOING FOR CONFORMITY TO SPECIFIED QUALITY, SIZE AND VARIETY.
- 5. PLANTS FURNISHED IN CONTAINERS SHALL HAVE THE ROOTS WELL ESTABLISHED IN THE SOIL MASS AND SHALL HAVE AT LEAST ONE (1) GROWING SEASON. ROOT-BOUND PLANTS OR INADEQUATELY SIZED CONTAINERS TO SUPPORT THE PLANT MAY BE DEEMED UNACCEPTABLE.
- 6. ALL WORK AND PLANTS SHALL BE DONE, INSTALLED AND DETAILED IN STRICT ACCORDANCE WITH PROJECT SPECIFICATIONS.
- 7. ALL PLANTS SHALL BE WATERED THOROUGHLY TWICE DURING THE FIRST 24-HOUR PERIOD AFTER PLANTING. ALL PLANTS SHALL BE WATERED WEEKLY, OR MORE OFTEN IF NECESSARY, DURING THE FIRST GROWING
- 8. ALL LANDSCAPE AREAS TO BE GRASS COMMON TO REGION, EXCEPT FOR INTERIOR LANDSCAPED ISLANDS OR WHERE OTHER PLANT MATERIAL IS SPECIFIED.
- 9. ALL TREES AND SHRUBS SHALL BE PLANTED IN MULCH BEDS WITH EDGE STRIPS TO SEPARATE TURF GRASS
- 10. THE CONTRACTOR SHALL REMOVE WEEDS, ROCKS, CONSTRUCTION ITEMS, ETC. FROM ANY LANDSCAPE AREA SO DESIGNATED TO REMAIN, WHETHER ON OR OFF-SITE. GRASS SEED OR PINE BARK MULCH SHALL BE APPLIED AS DEPICTED ON PLANS.
- 11. FINISHED GRADES IN LANDSCAPED ISLANDS SHALL BE INSTALLED SO THAT THEY ARE 1" HIGHER THAN THE TOP OF THE SURROUNDING CURB.
- 12. ALL LANDSCAPING SHALL MEET THE CITY OF PORTSMOUTH STANDARDS AND REGULATIONS.

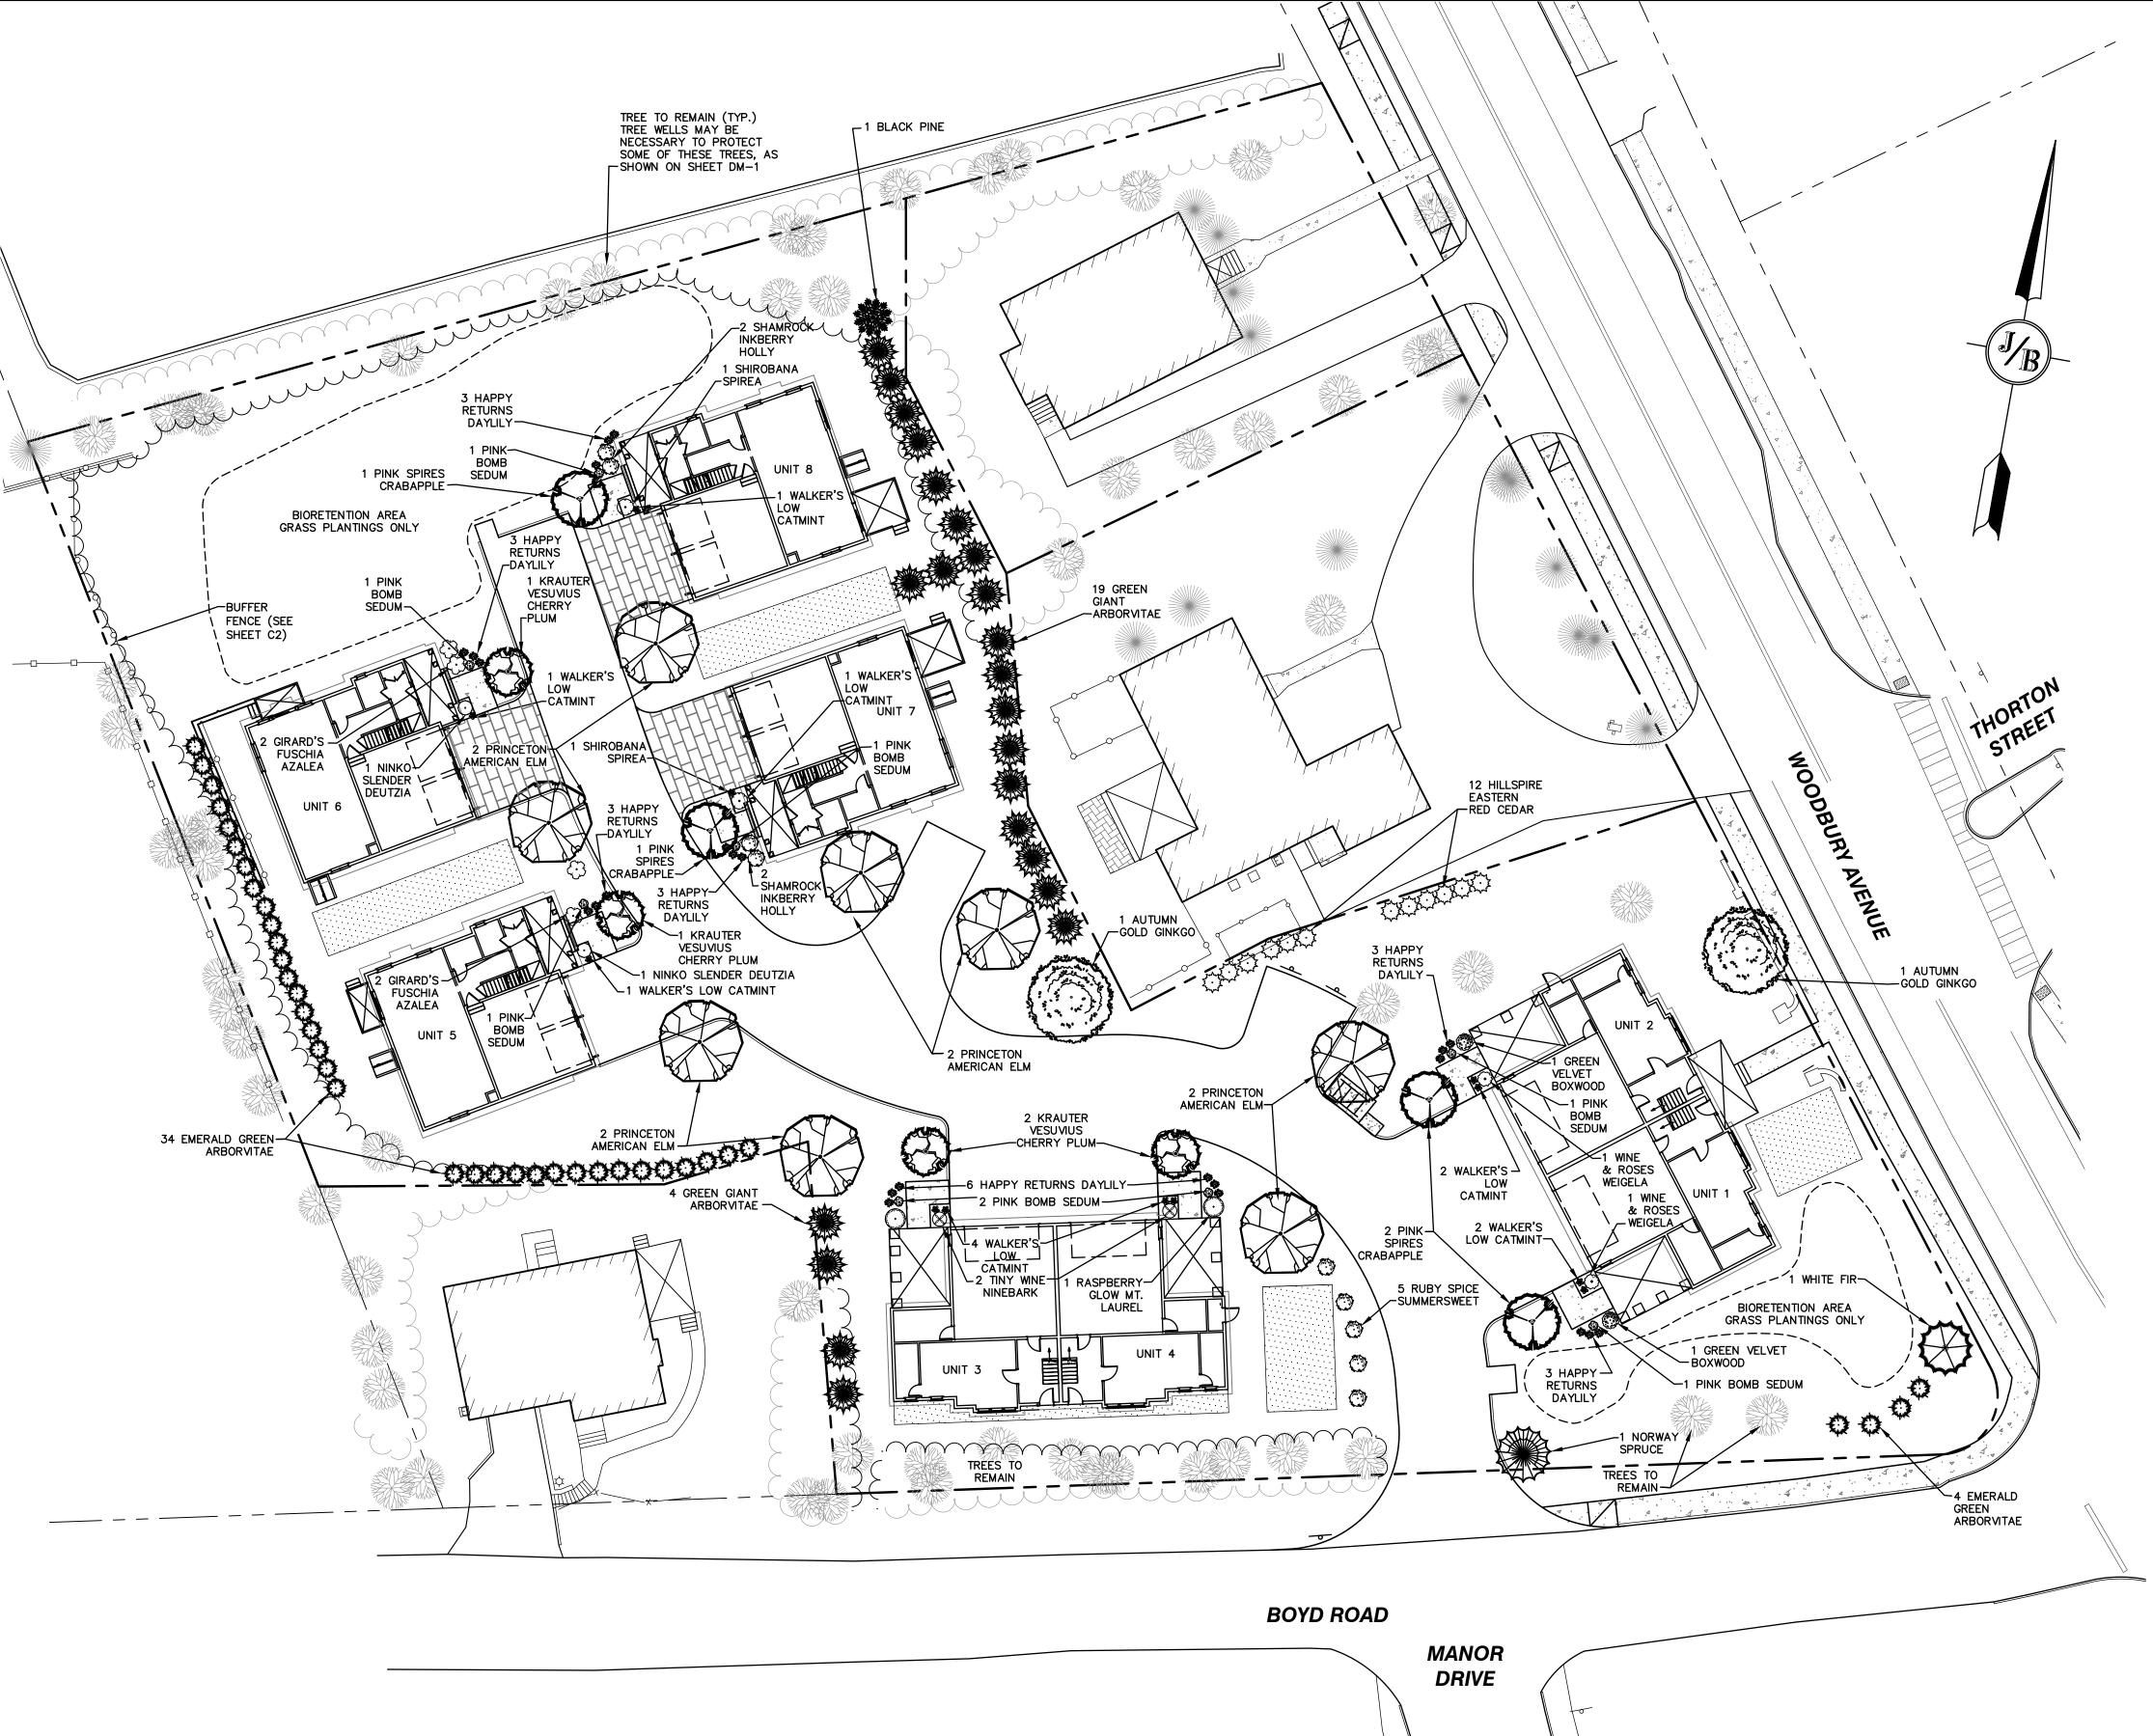- 13. EXISTING TREES TO REMAIN SHALL BE PROTECTED WITH TEMPORARY SNOW FENCING AT THE DRIPLINE OF THE TREE. THE CONTRACTOR SHALL NOT STORE VEHICLES OR MATERIALS WITHIN THE LANDSCAPED AREAS. ANY DAMAGE TO EXISTING TREES, SHRUBS OR LAWN SHALL BE REPAIRED BY THE CONTRACTOR AT NO ADDITIONAL COST TO THE OWNER.
- 14. ALL MULCH AREAS SHALL RECEIVE A 3" LAYER OF SHREDDED PINE BARK MULCH OVER A 10 MIL WEED MAT EQUAL TO 'WEEDBLOCK' BY EASY GARDENER OR DEWITT WEED BARRIER.
- 15. ALL LANDSCAPED AREAS SHALL HAVE SELECT MATERIALS REMOVED TO A DEPTH OF AT LEAST 12" BELOW FINISH GRADE. THE RESULTING VOID IS TO BE FILLED WITH A MINIMUM OF 9" HIGH-QUALITY SCREENED LOAM AMENDED WITH 3" OF AGED ORGANIC COMPOST.
- 16. THIS PLAN IS INTENDED FOR LANDSCAPING PURPOSES ONLY. REFER TO CIVIL/SITE DRAWINGS FOR OTHER SITE CONSTRUCTION INFORMATION.
- 17. IRRIGATION PIPING SYSTEM SHALL BE REVIEWED AND APPROVED BY OWNER AND ENGINEER PRIOR TO INSTALLATION.
- 18. THE PROPERTY OWNER AND ALL FUTURE PROPERTY OWNERS SHALL BE RESPONSIBLE FOR THE MAINTENANCE, REPAIR, AND REPLACEMENT OF ALL REQUIRED SCREENING AND LANDSCAPE MATERIALS.
- 19. ALL REQUIRED PLANT MATERIALS SHALL BE TENDED AND MAINTAINED IN A HEALTHY GROWING CONDITION, REPLACED WHEN NECESSARY, AND KEPT FREE OF REFUSE AND DEBRIS. ALL REQUIRED FENCES AND WALLS SHALL BE MAINTAINED IN GOOD REPAIR.
- 20. THE PROPERTY OWNER SHALL BE RESPONSIBLE TO REMOVE AND REPLACE DEAD OR DISEASED PLANT MATERIALS IMMEDIATELY WITH THE SAME TYPE, SIZE, AND QUANTITY OF PLANT MATERIALS AS ORIGINALLY INSTALLED, UNLESS ALTERNATIVE PLANTINGS ARE REQUESTED, JUSTIFIED, AND APPROVED BY THE PLANNING BOARD OR PLANNING DIRECTOR.
- 21. SEE TYPICAL PLANTING DETAILS ON SHEET D5.
- 22. IF TREES SCHEDULED TO REMAIN NEED TO BE REMOVED OR BECOME UNHEALTHY, ADDITIONAL TREES WILL NEED TO BE PLANTED TO THE SATISFACTION OF THE PLANNING DEPARTMENT.
- 23. NO LOAM OR OTHER TOPSOIL SHALL BE REMOVED FROM THE SITE AS PART OF SITE DEVELOPMENT. TOPSOIL SHALL BE APPROPRIATELY STOCKPILED AND STABILIZED FOR REDISTRIBUTION WITHIN NEW PLANTING AREAS.

Quantity	Botanical Name	Common Name	Size
	TREES		
1	Abies concolor	WHITE FIR	7-8 FT. HT.
2	Ginkgo biloba 'Autumn Gold'	AUTUMN GOLD GINKGO	3" CALIPER
12	Juniperus virginiana 'Hillspire'	HILLSPIRE EASTERN RED CEDAR	7-8 FT. HT.
4	Malus x 'Pink Spires'	PINK SPIRES CRABAPPLE	2" CALIPER
1	Picea abies	NORWAY SPRUCE	8-9 FT. HT.
1	Pinus nigra	BLACK PINE	7-8 FT. HT.
4	Prunus cerasifera 'Krauter Vesuvius'	KRAUTER VESUVIUS CHERRY PLUM	2" CALIPER
38	Thuja occidentalis 'Smaragd Emerald'	EMERALD GREEN ARBORVITAE	5-6 FT. HT.
23	Thuja plicata 'Green Giant'	GREEN GIANT ARBORVITAE	7-8 FT. HT.
8	Ulmus americana 'Princeton'	PRINCETON AMERICAN ELM	3" CALIPER
	SHRUBS		
4	Azalea 'Girard's Fuchsia'	GIRARD'S FUCHSIA AZALEA	5 GALLON
2	Buxus 'Green Velvet'	GREEN VELVET BOXWOOD	5 GALLON
2	Deutzia gracilis 'Nikko'	NIKKO SLENDER DEUTZIA	3 GALLON
4	llex glabra 'Shamrock'	SHAMROCK INKBERRY HOLLY	5 GALLON
2	Kalmia latifolia 'Raspberry Glow'	RASPBERRY GLOW MT LAUREL	5 GALLON
2	Physocarpus opulifolius 'SMNPOTW'	TINY WINE NINEBARK	3 GALLON
2	Spiraea japonica 'Shirobana'	SHIROBANA SPIREA	3 GALLON
5	Clethra alnifolia 'Ruby Spice'	RUBY SPICE SUMMERSWEET	3 GALLON
2	Weigela florida 'Alexandra'	WINE & ROSES WEIGELA	3 GALLON
	PERENNIALS		
24	Hemerocallis 'Happy Returns'	HAPPY RETURNS DAYLILY	1 GALLON
	Nepeta x faassenii 'Walker's Low'		
12 8	Sedum 'Pink Bomb'	WALKER'S LOW CATMINT PINK BOMB SEDUM	1 GALLON 1 GALLON
	OCCUR I THE BOTTO	I HAIT DOINID SEDOINI	I JALLON

GRAPHIC SCALE (IN FEET) 1 inch = 20 ft.

LANDSCAPE PLAN

Design: JAC	Draft: DJM	Date: 01/05/22			
Checked: JAC	Scale: 1"=20'	Project No.: 21254			
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Stratham, NH 03885


"GRAPEVINE RUN" Project: 212, 214, & 216 WOODBURY AVE. PORTSMOUTH, NH 03801 LOT 1: BK 4708 PG 979 LOT 2: BK 4582 PG 888 FREDERICK J. BAILEY III & JOYCE S. NELSON Owner of Record: 4 SHORE RD., WOLFEBORO, NH 03894 LOT 3: BK 3919 PG 1345

Plan Name:

FAX: 603-772-0227

E-MAIL: JBE@JONESANDBEACH.COM



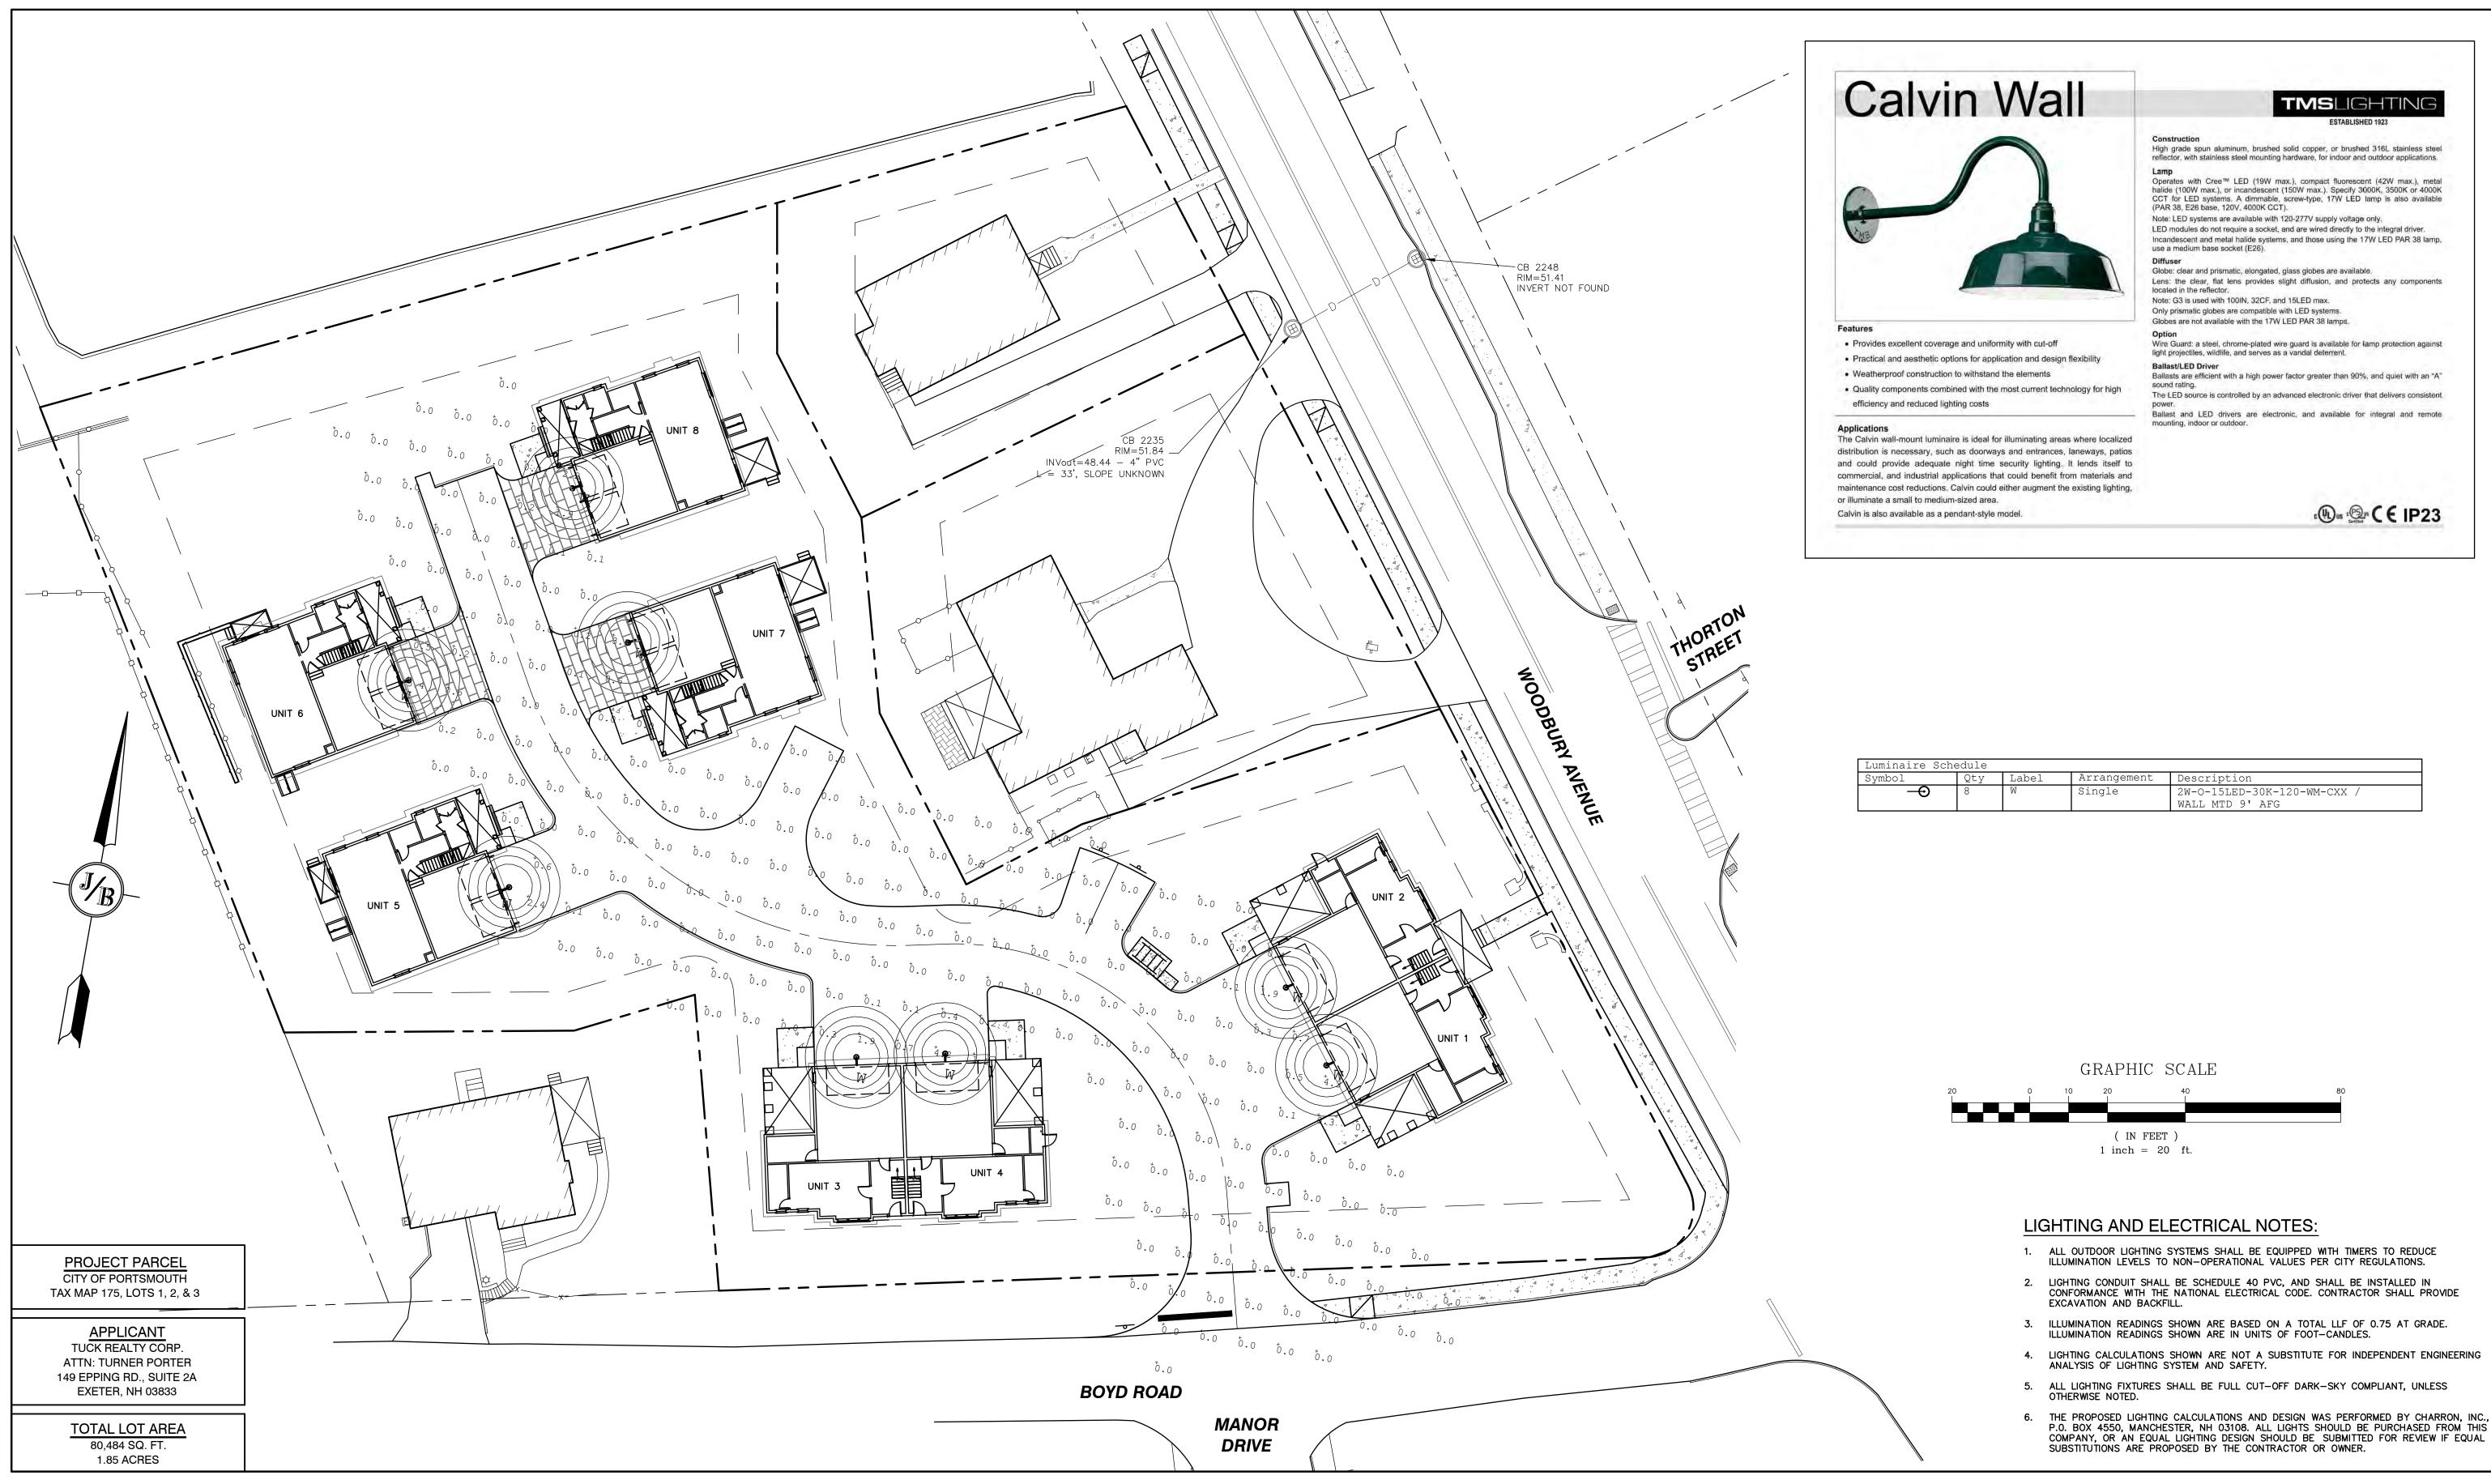

Design: JAC	Draft: DJM	Date: 01/05/22			
Checked: JAC	Scale: 1"=20'	Project No.: 21254			
Drawing Name: 21254-PLAN.dwg THIS PLAN SHALL NOT BE MODIFIED WITHOUT WRITTEN					

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6	10/18/22	REVISED PER REVIEW ENGINEER AND TAC COMMENTS	DJM
5	9/23/22	REVISED PER UTILITY COMPANY	DJM
4	9/20/22	REVISED PER REVIEW ENGINEER COMMENTS	DJM
3	9/14/22	ISSUED TO DEPARTMENT OF PUBLIC WORKS	DJM
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85 Portsmouth Ave. PO Box 219
Stratham, NH 03885

Civil Engineering Services

603-772-4746
FAX: 603-772-0227
E-MAIL: JBE@JONESANDBEACH.COM

Plan Name: LIGHTING PLAN

Project: "GRAPEVINE RUN"

Owner of Record: 212, 214, & 216 WOODBURY AVE. PORTSMOUTH, NH 03801


FREDERICK J. BAILEY III & JOYCE S. NELSON
4 SHORE RD., WOLFEBORO, NH 03894


LOT 1: BK 4708 PG 979
LOT 2: BK 4582 PG 888
LOT 3: BK 3919 PG 1345


L2SHEET 11 OF 23

JBE PROJECT NO. 21254

DRAWING No.

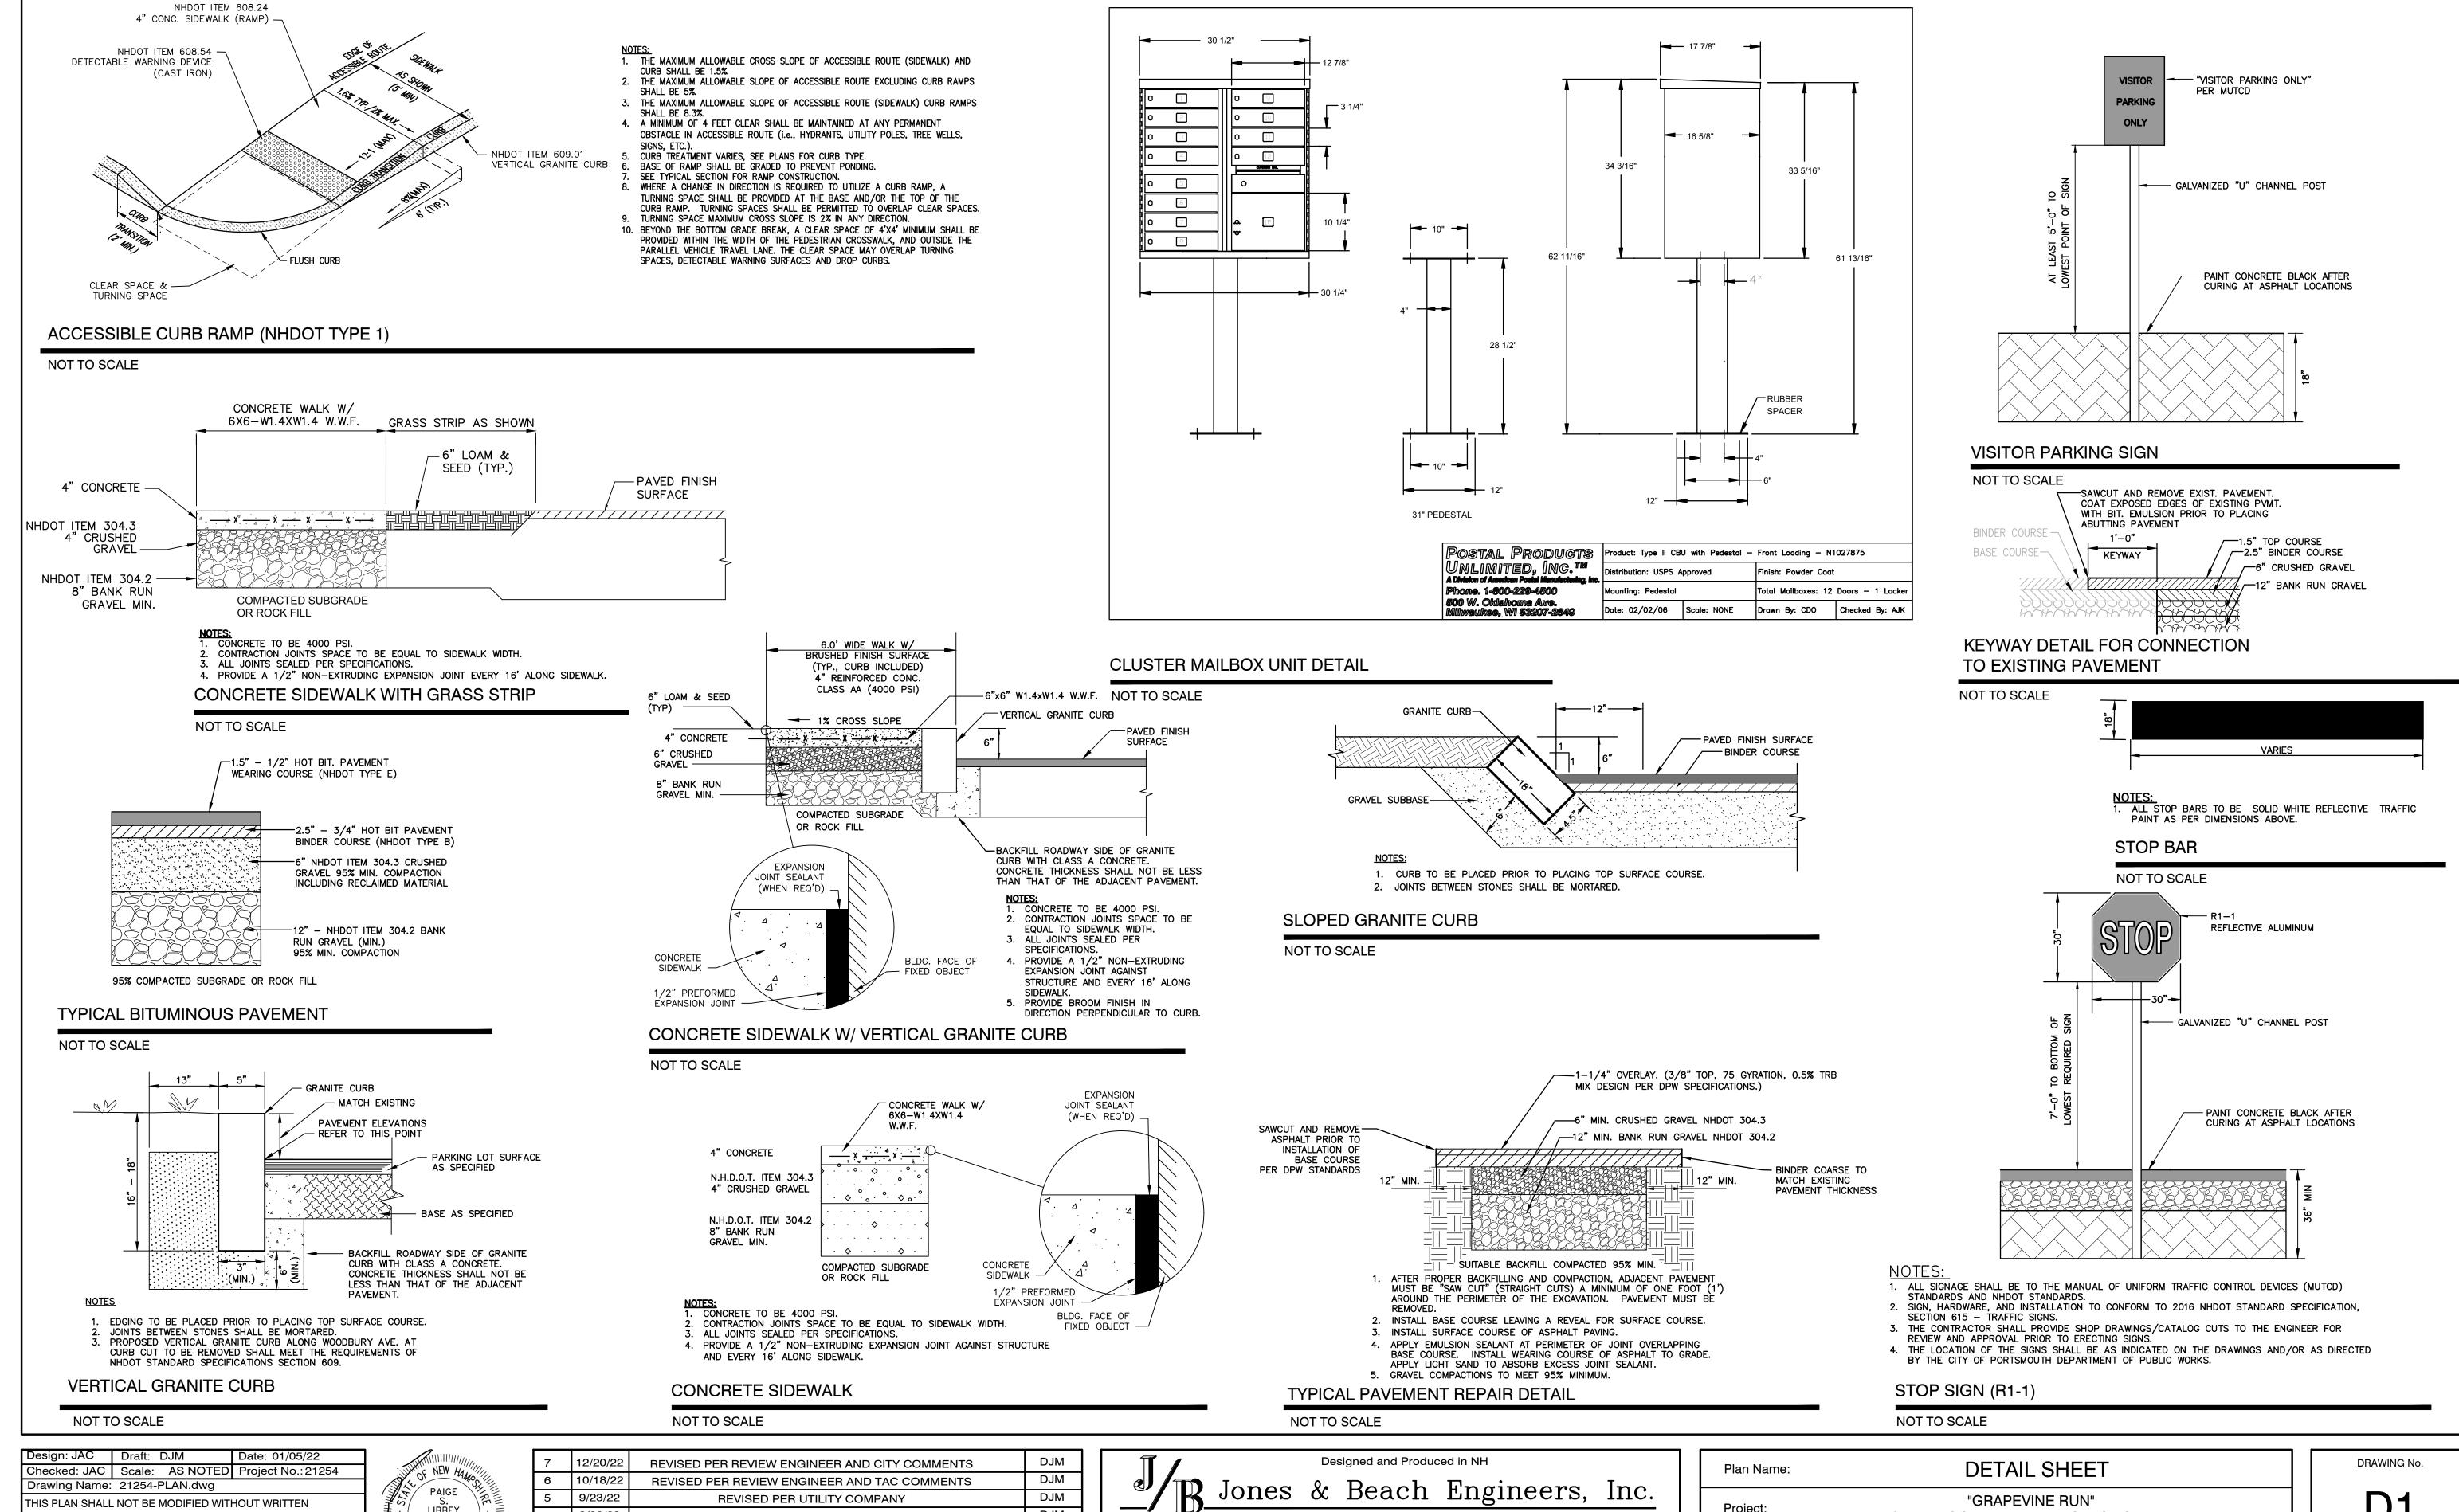

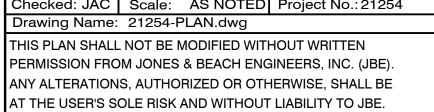

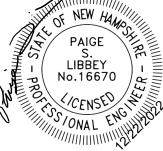


	7	12/20/22	REVISED PER REVIEW ENGINEER AND CITY COMMENTS	DJM
	6	10/18/22	REVISED PER REVIEW ENGINEER AND TAC COMMENTS	DJM
	5	9/23/22	REVISED PER UTILITY COMPANY	DJM
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	3	9/14/22	ISSUED TO DEPARTMENT OF PUBLIC WORKS	DJM
ļ	REV.	DATE	REVISION	BY



85 Portsmouth Ave. PO Box 219 Stratham, NH 03885	Civil	Engineering	603-772-4746 FAX: 603-772-0227 DNESANDBEACH.COM


Plan Name:	DETAIL SHEET
Project:	"GRAPEVINE RUN" 212, 214, & 216 WOODBURY AVE. PORTSMOUTH, NH 03801
Owner of Reco	rd: FREDERICK J. BAILEY III & JOYCE S. NELSON LOT 1: BK 4708 PG 979 LOT 2: BK 4582 PG 888 LOT 3: BK 3919 PG 1345



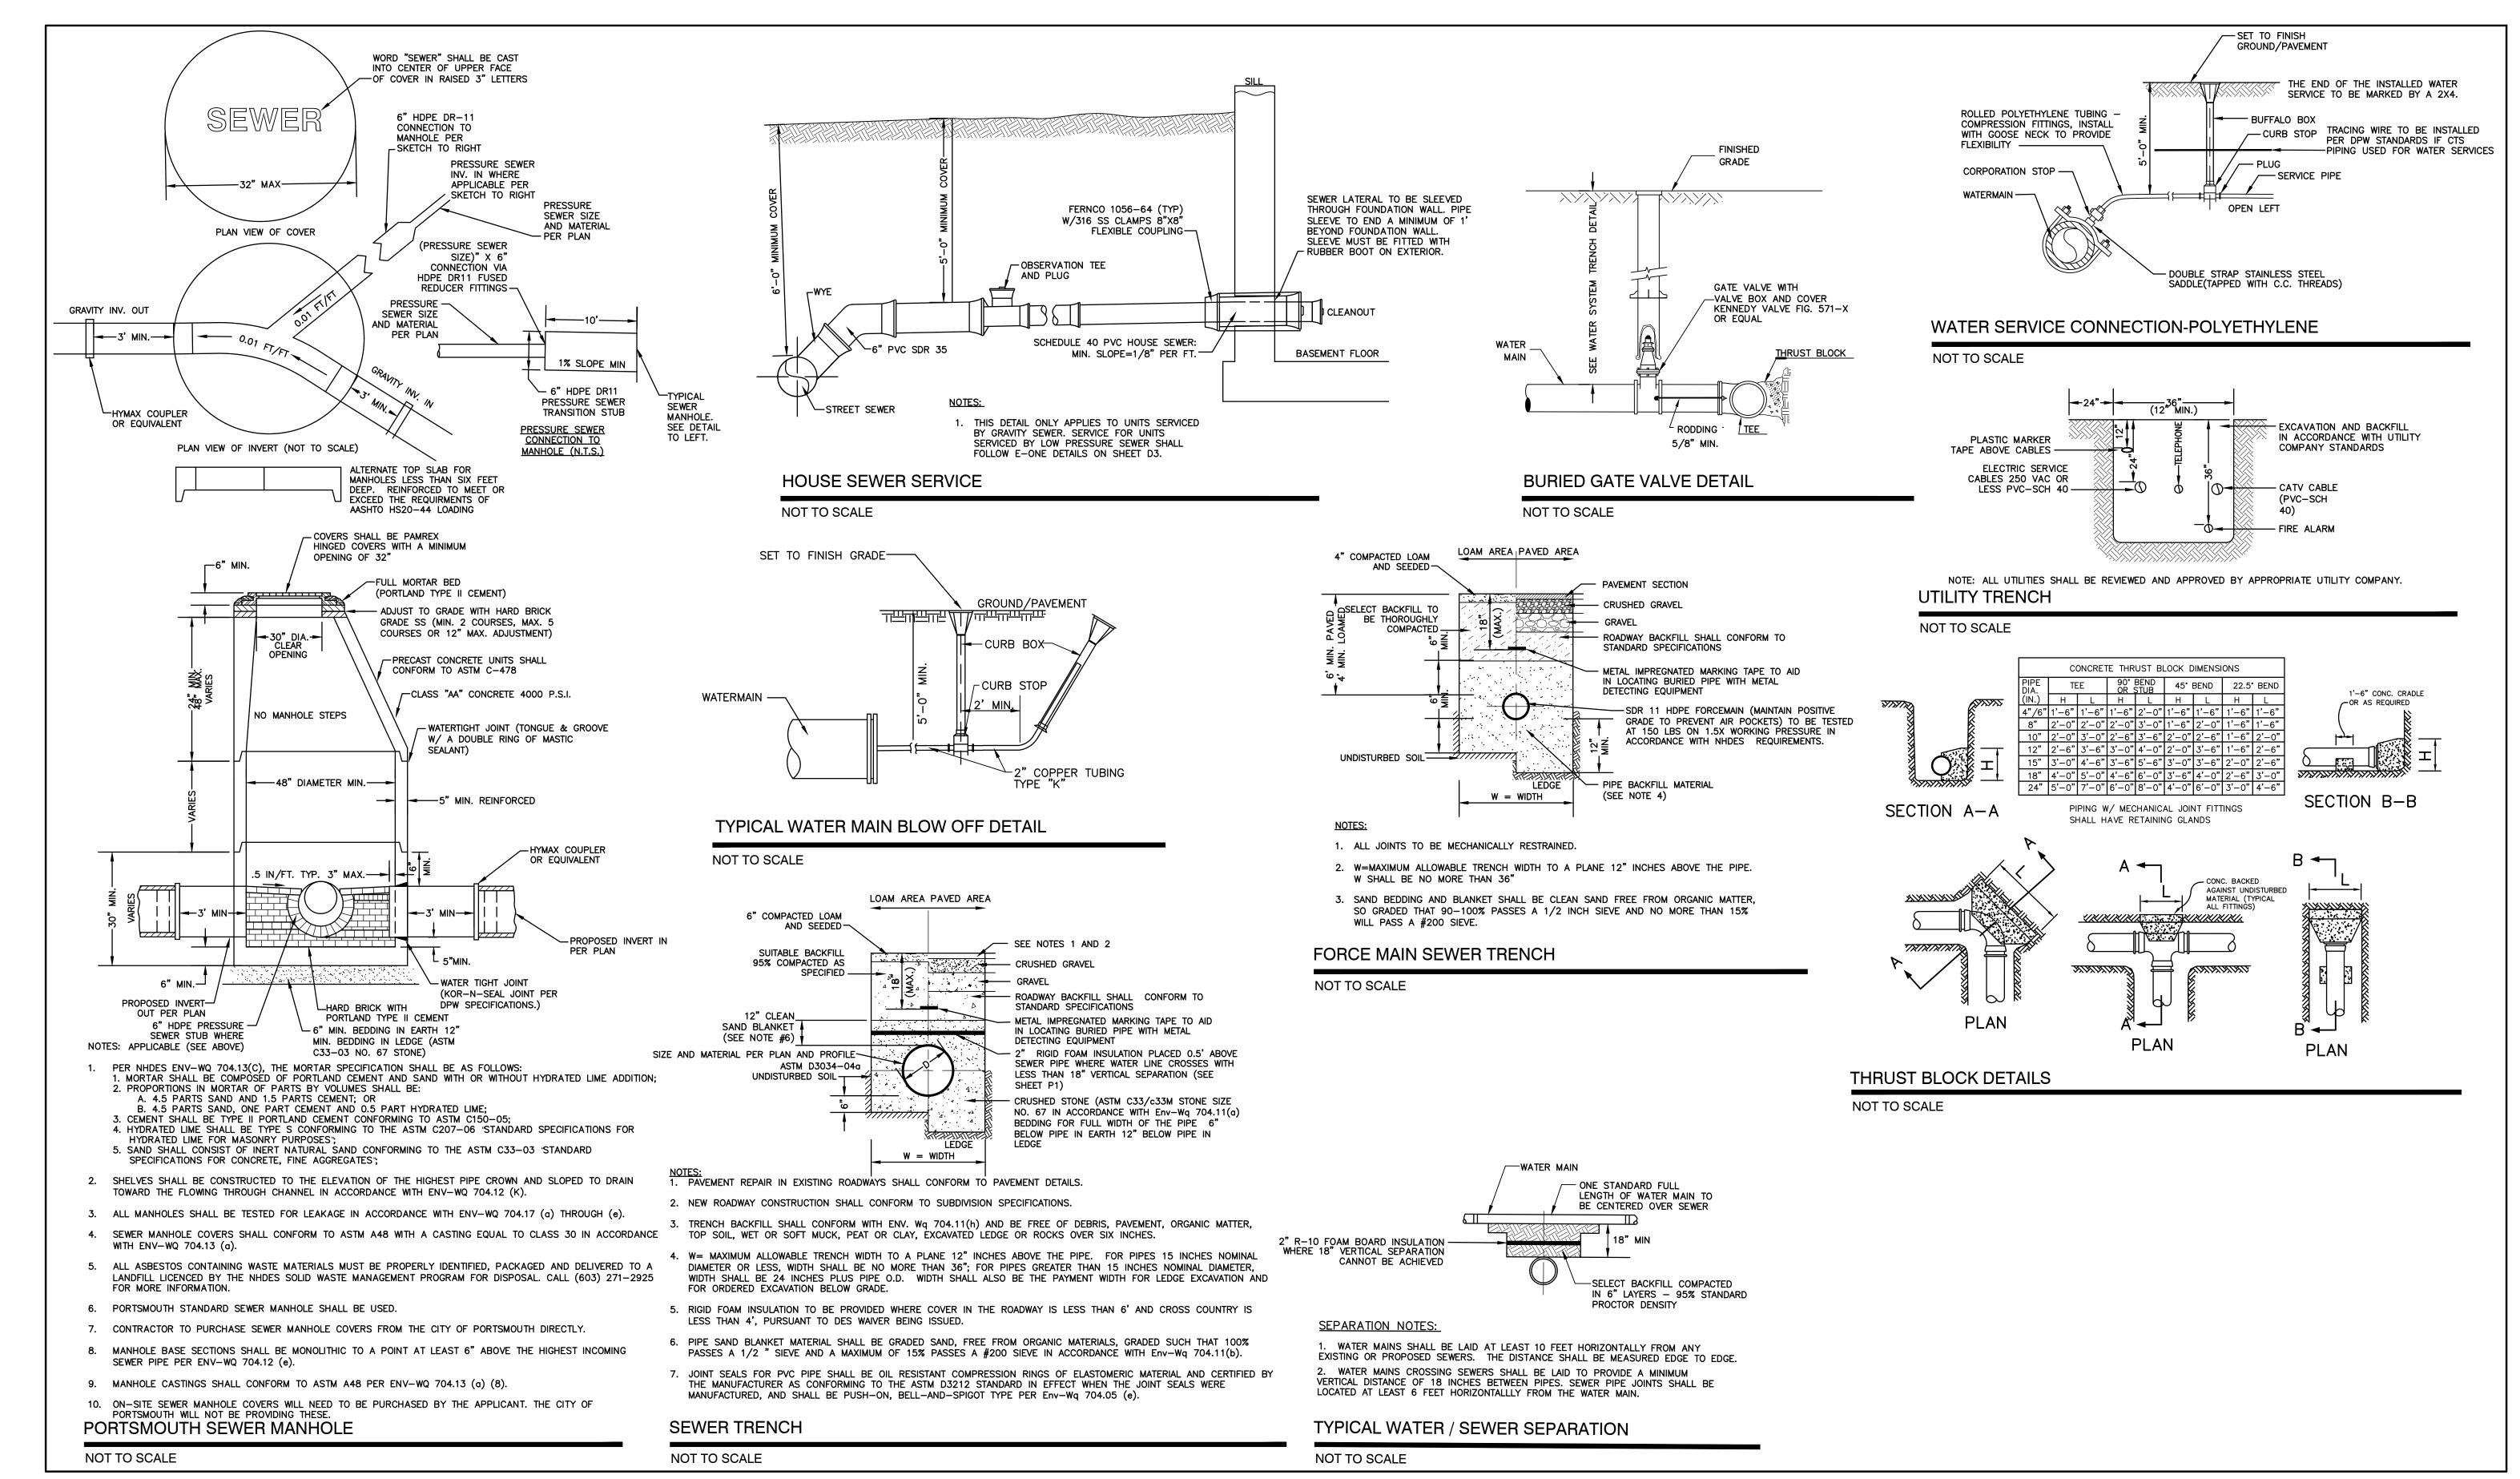

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V	3	9/14/22	ISSUED TO DEPARTMENT OF PUBLIC WORKS	DJM
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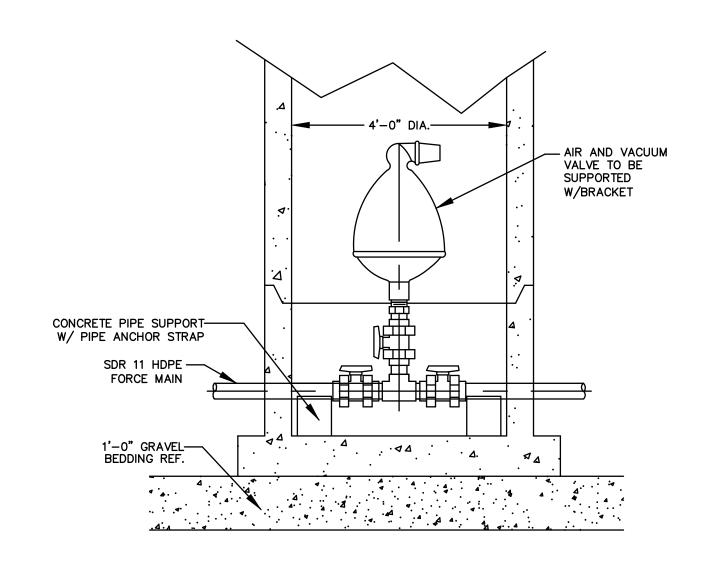
	Plan Name:	DETAIL SHEET	
	Project:	"GRAPEVINE RUN" 212, 214, & 216 WOODBURY AVE. PORTSMOUT	H, NH 03801
	Owner of Record	FREDERICK J. BAILEY III & JOYCE S. NELSON	LOT 1: BK 4708 PG 979 LOT 2: BK 4582 PG 888

4 SHORE RD., WOLFEBORO, NH 03894

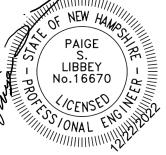SHEET 13 OF 23 JBE PROJECT NO. 21254


LOT 3: BK 3919 PG 1345

DRAWING No.



TERMINAL FLUSHING MANHOLE - OPTIONAL ELEV. VIEW


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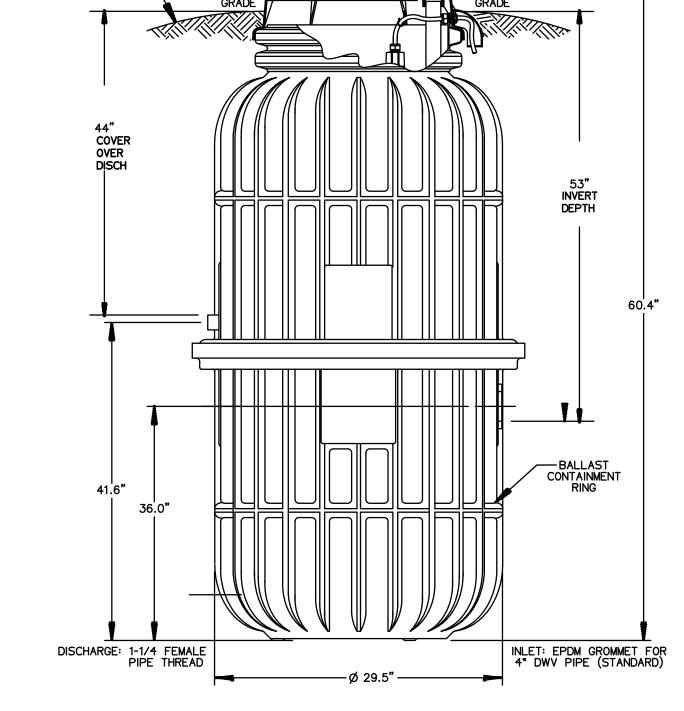
TERMINAL FLUSHING MANHOLE

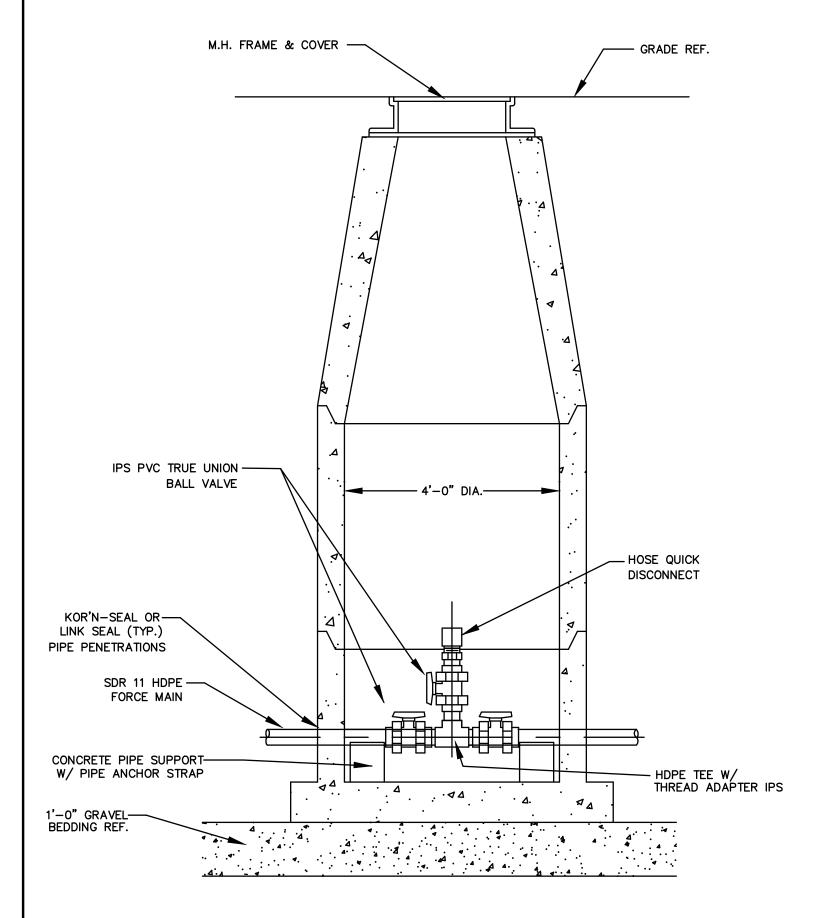NOT TO SCALE

Design: JAC	Draft: I	DJM	Date: 01/05/22			/()
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ANY ALTERATIONS, AUTHORIZED OR OTHERWISE, SHALL BE						
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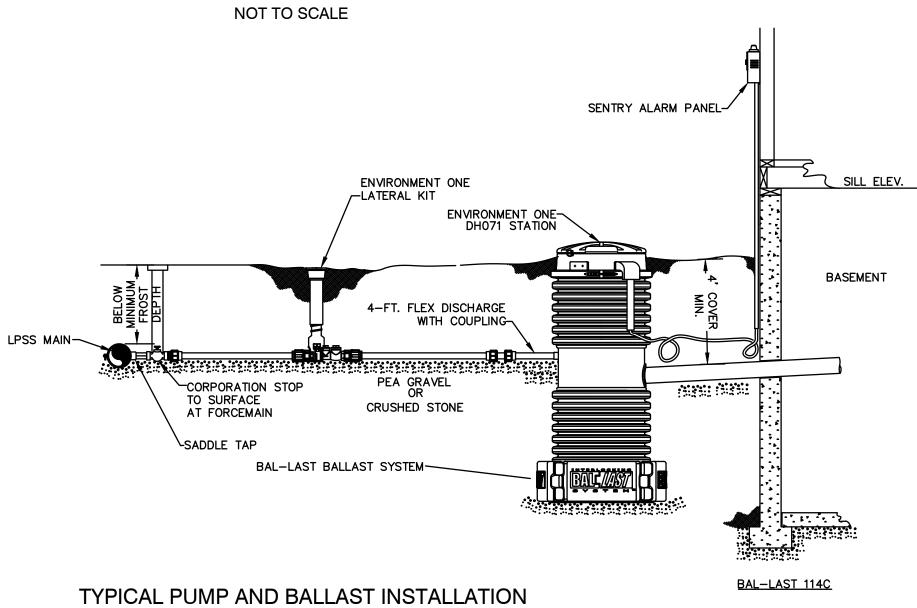
7	12/20/22	REVISED PER REVIEW ENGINEER AND CITY COMMENTS	DJM
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3	9/14/22	ISSUED TO DEPARTMENT OF PUBLIC WORKS	DJM
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DH071-93 GRINDER PUMP STATION

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GRADE MUSI —— SLOPE AWAY FROM STATION

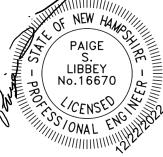


SDR 11 HDPE PIP EXTENSION TYPE CURB BOX WITH ARCH PATTERN BASE MATERIAL: ABS AVAILABLE LENGTHS	LID ASSEMBLY WITH PENTAGON HEAD PL MATERIAL: CAST IRON	1-1/4"
AVAILABLE LENGTHS		
AVAILABLE LENGTHS	EXTENSION TYPE	
COMPRESSION ADAPTER FITTING MATERIAL: POLYPROPYLENE (ASSEMBLED BY OTHERS) TO MAIN VALVE CURB STOP WITH FEMALE PIPE THREADS AND VALVE POSITION STOPS (OPEN/CLOSED) WITH INTEGRAL. CHECK VALVE MATERIAL: POLYPROPYLENE (ASSEMBLED BY OTHERS) NOTES: 1. SS CURB STOP/CHECK VALVE AND FITTINGS ARE PROVIDED SEPARATELY, TO BE ASSEMBLED BY OTHERS) NOTES: 1. SS CURB STOP/CHECK VALVE AND FITTINGS ARE PROVIDED SEPARATELY, TO BE ASSEMBLED BY OTHERS) NOTES: 1. SS CURB STOP/CHECK VALVE AND FITTINGS ARE PROVIDED SEPARATELY, TO BE ASSEMBLED BY OTHERS) NOTES: 1. SS CURB STOP/CHECK VALVE AND FITTINGS ARE PROVIDED SEPARATELY, TO BE ASSEMBLED BY OTHERS) NOTES: 1. SS CURB STOP/CHECK VALVE AND FITTINGS ARE PROVIDED SEPARATELY, TO BE ASSEMBLED BY OTHERS) TO THE MANUFACTURER'S INSTRUCTIONS **FOR SS FITTING INTO SS THREAD, USE PIPE DOPE OR TEFLON TAPE, NOT BOTH 3. ASSEMBLY IS TO BE PRESSURE TESTED (BY OTHERS) 4. ASSEMBLY IS TO BE USED WITH SDRITH HOPE PIPE 5. TO ORDER SS LATERAL KIT, USE PART NUMBER NCO193GO1 6. CURB BOX IS TO BE ORDERED SEPARATELY, SEE ABOVE **COMPRESSION ADAPTER FITTING MATERIAL: POLYPROPYLENE (ASSEMBLE BY OTHERS) KIT PARTS ARE NOT ASSEMBLED SGS DN 11/02/11 B 3/16 DR BY CHYD DATE ISSUE SCAI **COMPRESSION ADAPTER FITTING (ASSEMBLE BY OTHERS) SGS DN 11/02/11 B 3/16 DR BY CHYD DATE ISSUE SCAI **COMPRESSION ADAPTER FITTING (SUPPLIED BY OTHERS) SGS DN 11/02/11 B 3/16 DR BY CHYD DATE ISSUE SCAI **COMPRESSION ADAPTER FITTING (SUPPLIED BY OTHERS) SGS DN 11/02/11 B 3/16 DR BY CHYD DATE ISSUE SCAI **COMPRESSION ADAPTER FITTING (SUPPLIED BY OTHERS) SGS DN 11/02/11 B 3/16 DR BY CHYD DATE ISSUE SCAI **COMPRESSION ADAPTER FITTING (SUPPLIED BY OTHERS) SGS DN 11/02/11 B 3/16 DR BY CHYD DATE ISSUE SCAI **COMPRESSION ADAPTER FITTING (SUPPLIED BY OTHERS) SGS DN 11/02/11 B 3/16 DR BY CHYD DATE ISSUE SCAI **COMPRESSION ADAPTER FITTING (SUPPLIED BY OTHERS) SGS DN 11/02/11 B 3/16 DR BY CHYD DATE ISSUE SCAI **COMPRESSION ADAPTER FITTING (SUPPLIED BY OTHERS) SGS DN 11/02/11 B 3/16 DR BY CHYD DATE ISSUE SC	AVAILABLE LEN	IGTHS 18-30" PB0930G01 30-42" PB0930G02 36-54" PB0930G03 42-66" PB0930G04 48-78" PB0930G05
TO MAIN VALVE CURB STOP WITH FEMALE PIPE THREADS AND VALVE POSITION STOPS (OPEN/CLOSED) WITH INTEGRAL CHECK VALVE MATERIAL: POLYPROPYLENE (ASSEMBLED BY OTHERS) TO PUI VALVE CURB STOP WITH FEMALE PIPE THREADS AND VALVE POSITION STOPS (OPEN/CLOSED) WITH INTEGRAL CHECK VALVE MITH INTEGRAL CHECK VALVE MATERIAL: POLYPROPYLENE (ASSEMBLED BY OTHERS) NOTES: KIT PARTS ARE NOT ASSEMBLED SEPARATELY, TO BE ASSEMBLED BY OTHERS 1. SS CURB STOP/CHECK VALVE AND FITTINGS ARE PROVIDED SEPARATELY, TO BE ASSEMBLED BY OTHERS 2. TO ASSEMBLE, APPLY A DOUBLE LAYER OF TEFLON TAPE, AND A LAYER OF PIPE DOPE (SUPPLIED BY OTHERS) THREADS ON THE PLASTIC FITTINGS AND INSTALL PER THE MANUFACTURER'S INSTRUCTIONS FOR SETTITING INTO SS THREAD, USE PIPE DOPE OR TEFLON TAPE, NOT BOTH 3. ASSEMBLY IS TO BE PRESSURE TESTED (BY OTHERS) 5. TO ORDER SS LATERAL KIT, USE PART NUMBER NC0193G01 6. CURB BOX IS TO BE ORDERED SEPARATELY, SEE ABOVE NAO330P02	ORDERED SEPAR	RATELY USING PART NUMBER FROM ABOVE
TO MAIN VALVE CURB STOP WITH FEMALE PIPE THREADS AND VALVE POSITION STOPS (PPEN/CLOSED) WITH INTEGRAL. CHECK VALVE MATERIAL: STAINLESS STEEL COMPRESSION ADAPTER FITTING MATERIAL: STAINLESS STEEL COMPRESSION ADAPTER FITTING MATERIAL: STAINLESS STEEL COMPRESSION ADAPTER FITTING MATERIAL: STAINLESS STEEL COMPLED BY OTHERS) NOTES: 1. SS CURB STOP/CHECK VALVE AND FITTINGS ARE PROVIDED SEPARATELY, TO BE ASSEMBLED BY OTHERS) 2. TO ASSEMBLE, APPLY A DOUBLE LAYER OF TEFLON TAPE, AND A LAYER OF PIPE DOPE (SUPPLIED BY OTHERS) TO THE THREADS ON THE PLASTIC FITTINGS AND INSTALL PER THE MANUFACTURERS INSTRUCTIONS *FOR SS FITTING INTO SS THREAD, USE PIPE DOPE OR TEFLON TAPE, NOT BOTH 3. ASSEMBLY IS TO BE PRESSURE TESTED (BY OTHERS) 4. ASSEMBLY IS TO BE USED WITH SDR11 HDPE PIPE 5. TO ORDER SS LATERAL KIT, USE PART NUMBER NC0193G01 6. CURB BOX IS TO BE ORDERED SEPARATELY, SEE ABOVE TO AND THE THREADS KIT PARTS ARE NOT ASSEMBLED SGS DN 11/02/11 B 3/16 DR BY CHK'D DATE ISSUE SCAIN SEWIER SYSTEMS STAINLESS STEEL LATERAL KIT 1-1/4* SDR 11 HDPE PIPE NAO330P02		MATERIAL: POLYPROPYLENE
VALVE CURB STOP WITH FEMALE PIPE THREADS AND VALVE POSITION STOPS (OPEN/CLOSED) WITH INTEGRAL CHECK VALVE MATERIAL: STAINLESS STEEL COMPRESSION ADAPTER FITTING MATERIAL: POLYPROPYLENE (ASSEMBLED BY OTHERS) NOTES: 1. SS CURB STOP/CHECK VALVE AND FITTINGS ARE PROVIDED SEPARATELY, TO BE ASSEMBLED BY OTHERS 2. TO ASSEMBLE, APPLY A DOUBLE LAYER OF TEFLON TAPE, AND A LAYER OF PIPE DOPE (SUPPLIED BY OTHERS) TO THE THREADS ON THE PLASTIC FITTINGS AND INSTALL PER THE MANUFACTURER'S INSTRUCTIONS *FOR SS FITTING INTO SS THREAD, USE PIPE DOPE OR TEFLON TAPE, NOT BOTH 3. ASSEMBLY IS TO BE PRESSURE TESTED (BY OTHERS) 4. ASSEMBLY IS TO BE USED WITH SDR11 HDPE PIPE 5. TO ORDER SS LATERAL KIT, USE PART NUMBER NC0193G01 6. CURB BOX IS TO BE ORDERED SEPARATELY, SEE ABOVE	HDPE PIPE ' a '	MATERIAL: POLYPROPYLENE \
VALVE CURB STOP WITH FEMALE PIPE THREADS AND VALVE POSITION STOPS (OPEN/CLOSED) WITH INTEGRAL CHECK VALVE MATERIAL: STAINLESS STEEL COMPRESSION ADAPTER FITTING MATERIAL: POLYPROPYLENE (ASSEMBLED BY OTHERS) NOTES: 1. SS CURB STOP/CHECK VALVE AND FITTINGS ARE PROVIDED SEPARATELY, TO BE ASSEMBLED BY OTHERS 2. TO ASSEMBLE, APPLY A DOUBLE LAYER OF TEFLON TAPE, AND A LAYER OF PIPE DOPE (SUPPLIED BY OTHERS) TO THE THREADS ON THE PLASTIC FITTINGS AND INSTALL PER THE MANUFACTURER'S INSTRUCTIONS *FOR SS FITTING INTO SS THREAD, USE PIPE DOPE OR TEFLON TAPE, NOT BOTH 3. ASSEMBLY IS TO BE PRESSURE TESTED (BY OTHERS) 4. ASSEMBLY IS TO BE USED WITH SDR11 HDPE PIPE 5. TO ORDER SS LATERAL KIT, USE PART NUMBER NC0193G01 6. CURB BOX IS TO BE ORDERED SEPARATELY, SEE ABOVE		
1. SS CURB STOP/CHECK VALVE AND FITTINGS ARE PROVIDED SEPARATELY, TO BE ASSEMBLED BY OTHERS 2. TO ASSEMBLE, APPLY A DOUBLE LAYER OF TEFLON TAPE, AND A LAYER OF PIPE DOPE (SUPPLIED BY OTHERS) TO THE THREADS ON THE PLASTIC FITTINGS AND INSTALL PER THE MANUFACTURER'S INSTRUCTIONS *FOR SS FITTING INTO SS THREAD, USE PIPE DOPE OR TEFLON TAPE, NOT BOTH 3. ASSEMBLY IS TO BE PRESSURE TESTED (BY OTHERS) 4. ASSEMBLY IS TO BE USED WITH SDR11 HDPE PIPE 5. TO ORDER SS LATERAL KIT, USE PART NUMBER NC0193G01 6. CURB BOX IS TO BE ORDERED SEPARATELY, SEE ABOVE SGS DN 11/02/11 B 3/16 DR BY CHK'D DATE ISSUE SCALE **SCHIPT OF THE MANUFACTURER'S STAIL SOLE SCALE **SCHIPT OF THE MANUFACTURER'S INSTRUCTIONS **SEWIER **SYSTEMS** **STAINLESS STEEL LATERAL KIT 1-1/4* SDR 11 HDPE PIPE **SEWIER **SYSTEMS** **NA O 3 3 0 P 0 2	VALVE CURB STOP WITH FEMALE PIPE THREADS AND VALVE POSITION STOPS (OPEN/CLOSED) WITH INTEGRAL CHECK VALVE MATERIAL: STAINLESS STEEL COMPRESSION ADAPTER FITTING MATERIAL: POLYPROPYLENE	1-1/4" SDR 11 POLYETHYLENE PIPE
SEPARATELY, TO BE ASSEMBLED BY OTHERS 2. TO ASSEMBLE, APPLY A DOUBLE LAYER OF TEFLON TAPE, AND A LAYER OF PIPE DOPE (SUPPLIED BY OTHERS) TO THE THREADS ON THE PLASTIC FITTINGS AND INSTALL PER THE MANUFACTURER'S INSTRUCTIONS *FOR SS FITTING INTO SS THREAD, USE PIPE DOPE OR TEFLON TAPE, NOT BOTH 3. ASSEMBLY IS TO BE PRESSURE TESTED (BY OTHERS) 4. ASSEMBLY IS TO BE USED WITH SDR11 HDPE PIPE 5. TO ORDER SS LATERAL KIT, USE PART NUMBER NC0193G01 6. CURB BOX IS TO BE ORDERED SEPARATELY, SEE ABOVE DR BY CHK'D DATE ISSUE SCAL **SOLUTION TAPE, AND SEWER SYSTEMS STAINLESS STEEL LATERAL KIT 1-1/4" SDR 11 HDPE PIPE NAO330P02	NOTES:	KIT PARTS ARE NOT ASSEMBLED
2. TO ASSEMBLE, APPLY A DOUBLE LAYER OF TEFLON TAPE, AND A LAYER OF PIPE DOPE (SUPPLIED BY OTHERS) TO THE THREADS ON THE PLASTIC FITTINGS AND INSTALL PER THE MANUFACTURER'S INSTRUCTIONS *FOR SS FITTING INTO SS THREAD, USE PIPE DOPE OR TEFLON TAPE, NOT BOTH 3. ASSEMBLY IS TO BE PRESSURE TESTED (BY OTHERS) 4. ASSEMBLY IS TO BE USED WITH SDR11 HDPE PIPE 5. TO ORDER SS LATERAL KIT, USE PART NUMBER NC0193G01 6. CURB BOX IS TO BE ORDERED SEPARATELY, SEE ABOVE	1. SS CURB STOP/CHECK VALVE AND FITTINGS ARE PROVIDED SEPARATELY, TO BE ASSEMBLED BY OTHERS	SGS DN 11/02/11 B 3/16
3. ASSEMBLY IS TO BE PRESSURE TESTED (BY OTHERS) 4. ASSEMBLY IS TO BE USED WITH SDR11 HDPE PIPE 5. TO ORDER SS LATERAL KIT, USE PART NUMBER NC0193G01 6. CURB BOX IS TO BE ORDERED SEPARATELY, SEE ABOVE STAINLESS STEEL LATERAL KIT 1-1/4" SDR 11 HDPE PIPE NA0330P02	A LAYER OF PIPE DOPE (SUPPLIED BY OTHERS) TO THE THREADS ON THE PLASTIC FITTINGS AND INSTALL PER THE MANUFACTURER'S INSTRUCTIONS *FOR SS FITTING INTO SS THREAD, USE PIPE DOPE	eone
5. TO ORDER SS LATERAL KIT, USE PART NUMBER NC0193G01 6. CURB BOX IS TO BE ORDERED SEPARATELY, SEE ABOVE NAO330P02		STAINLESS STEEL LATERAL KIT
AINLESS STEEL LATERAL KIT	5. TO ORDER SS LATERAL KIT, USE PART NUMBER NC0193G01	
	TAINLESS STEEL LATERAL KIT	1

Designed and Produced in NH Jones & Beach Engineers, Inc. 85 Portsmouth Ave. Civil Engineering Services
PO Box 219
Stratham, NH 03885 Services 603-772-4746 FAX: 603-772-0227 E-MAIL: JBE@JONESANDBEACH.COM

	Plan Name:	DETAIL SHEET	
	Project:	"GRAPEVINE RUN" 212, 214, & 216 WOODBURY AVE. PORTSMOUT	ΓH, NH 03801
	Owner of Record	FREDERICK J. BAILEY III & JOYCE S. NELSON 4 SHORE RD., WOLFEBORO, NH 03894	LOT 1: BK 4708 PG LOT 2: BK 4582 PG LOT 3: BK 3919 PG

DRAWING No. SHEET 14 OF 23 JBE PROJECT NO. 21254

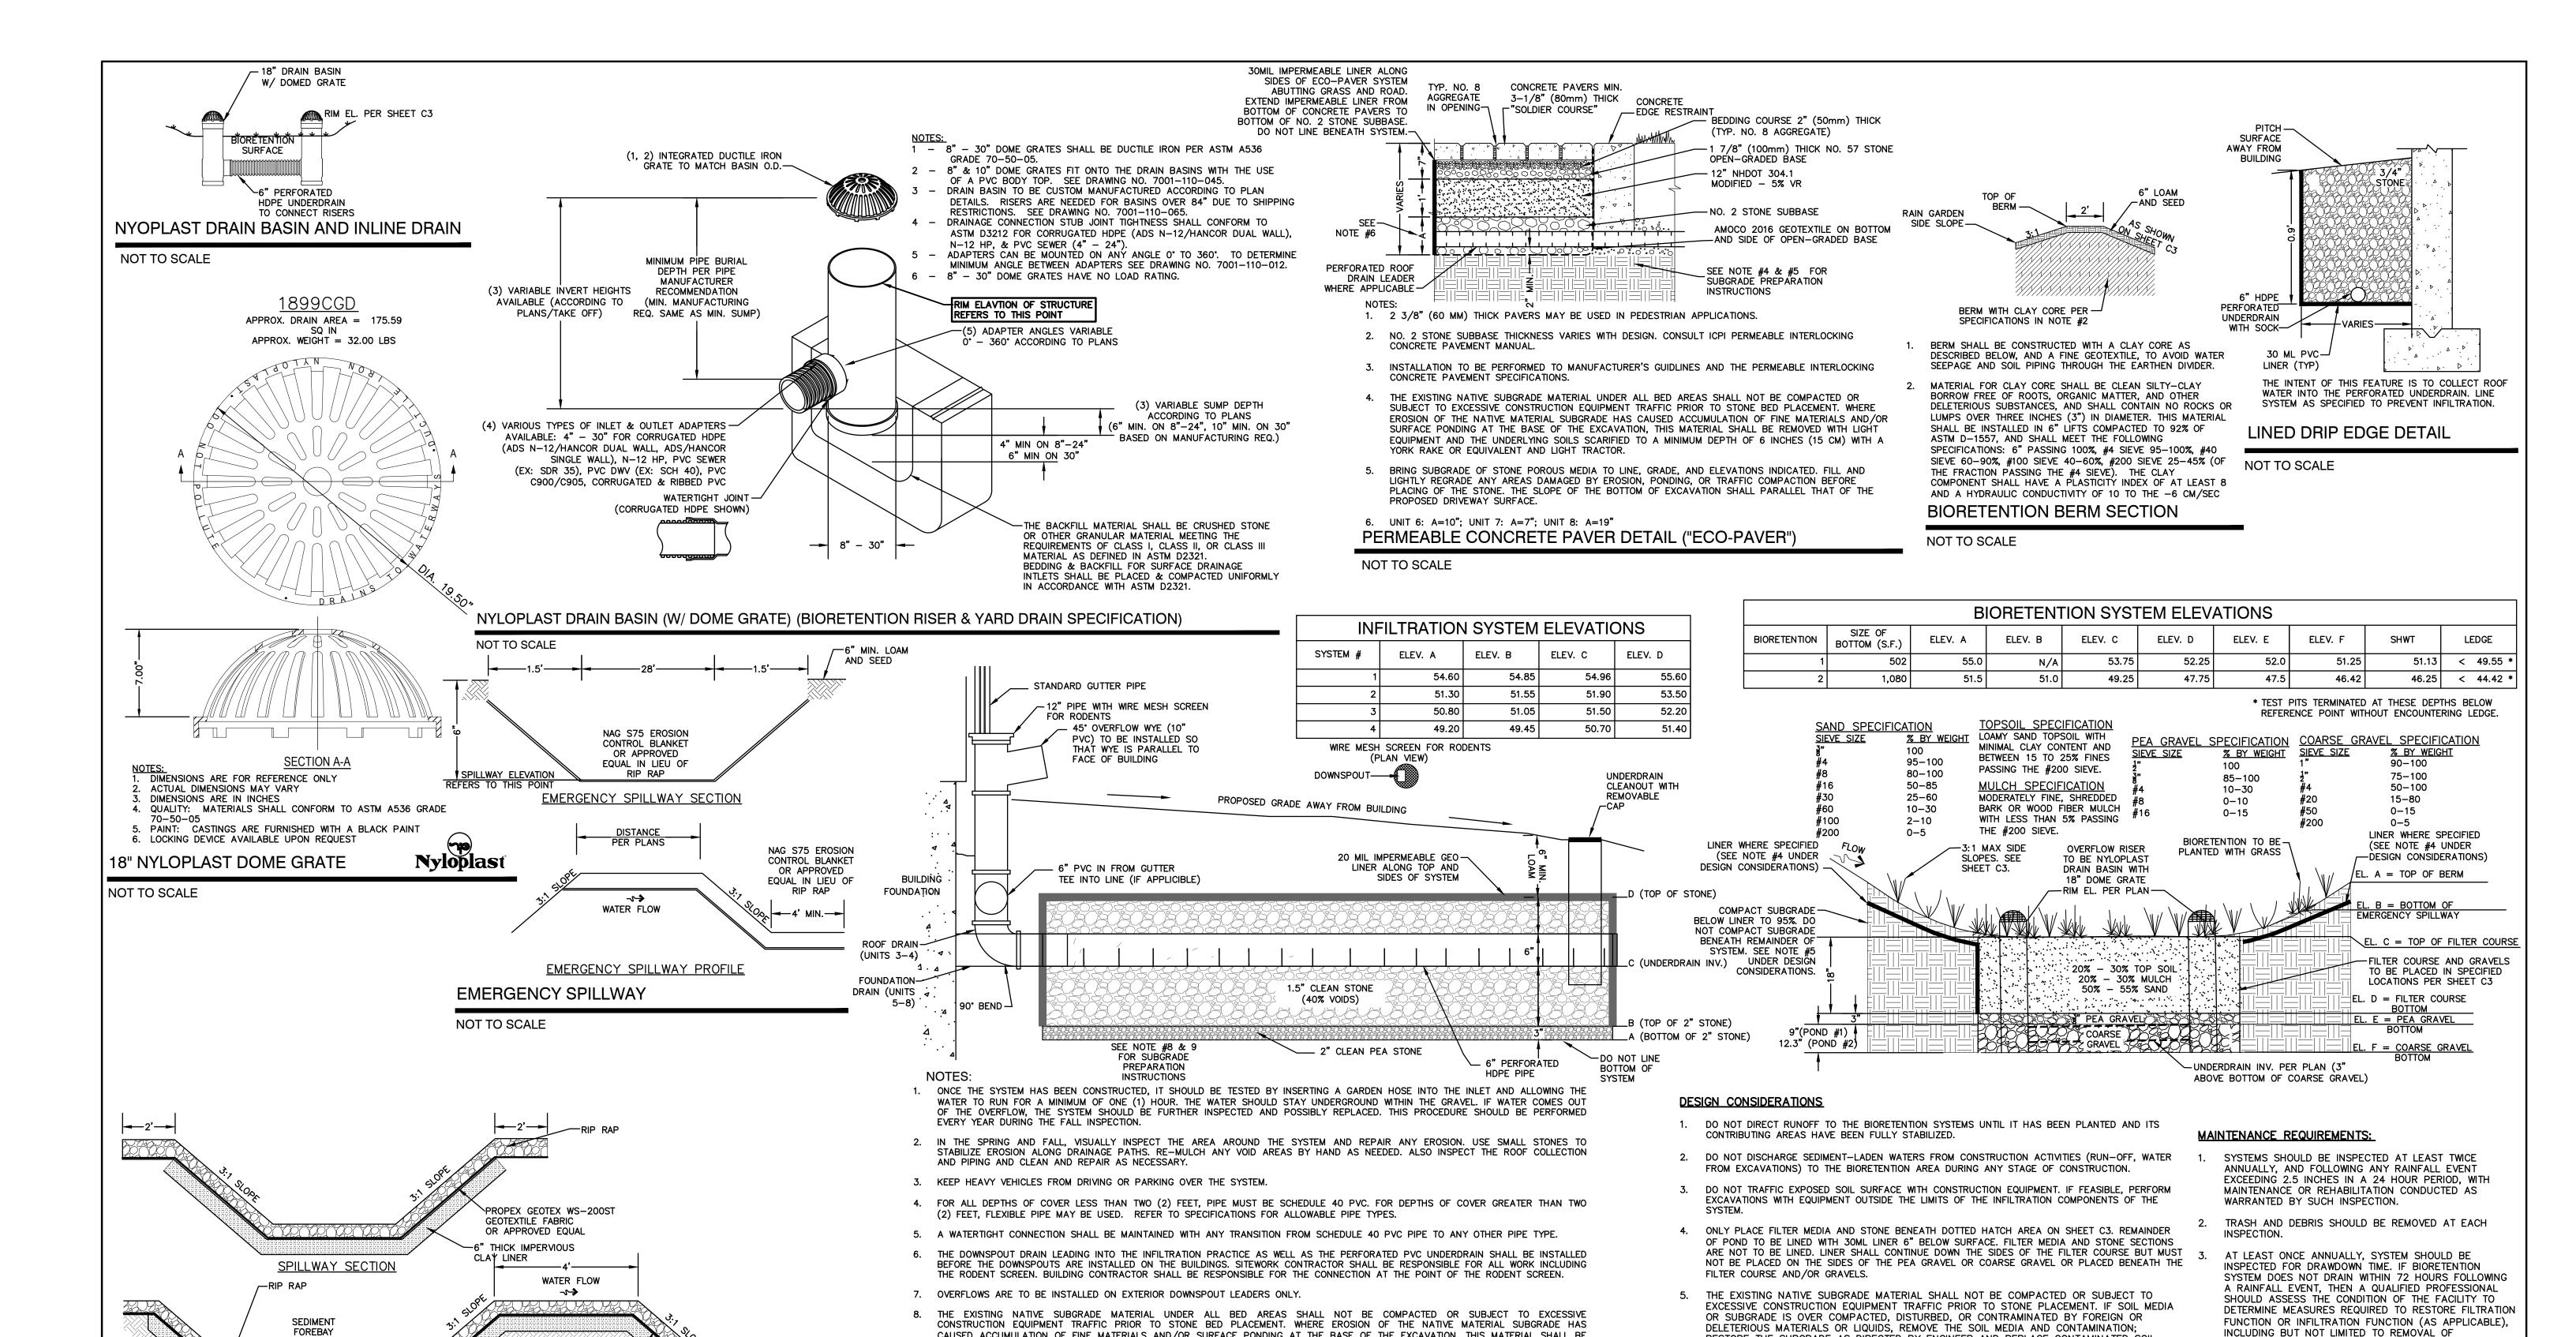

CAUSED ACCUMULATION OF FINE MATERIALS AND/OR SURFACE PONDING AT THE BASE OF THE EXCAVATION, THIS MATERIAL SHALL BE

REMOVED WITH LIGHT EQUIPMENT AND THE UNDERLYING SOILS SCARIFIED TO A MINIMUM DEPTH OF 6 INCHES (15 CM) WITH A YORK

BRING SUBGRADE OF STONE POROUS MEDIA TO LINE, GRADE, AND ELEVATIONS INDICATED. FILL AND LIGHTLY REGRADE ANY AREAS

DAMAGED BY EROSION, PONDING, OR TRAFFIC COMPACTION BEFORE PLACING OF THE STONE. THE BOTTOM OF EXCAVATION SHALL BE


10. UNITS 3&4: STONE INFILTRATION IS FOR ROOF WATER ONLY. UNITS 5-8: STONE INFILTRATION IS FOR FOUNDATION DRAINAGE ONLY. DO

Design: JAC	Draft: DJM	Date: 01/05/22				
Checked: JAC	Scale: AS NOTED	Project No.: 21254				
Drawing Name:	21254-PLAN.dwg					
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SEDIMENT FOREBAY SPILLWAY

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PROPEX GEOTEX WS-200ST

SPILLWAY PROFILE

THICK IMPERVIOUS

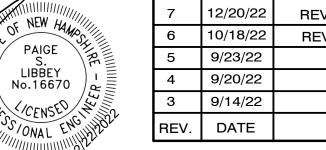CLAY LINER

GEOTEXTILE FABRIC

OR APPROVED EQUAL

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	6	10/18/22	REVISED PER REVIEW ENGINEER AND TAC COMMENTS	DJM
	5	9/23/22	REVISED PER UTILITY COMPANY	DJM
	4	9/20/22	REVISED PER REVIEW ENGINEER COMMENTS	DJM
	3	9/14/22	ISSUED TO DEPARTMENT OF PUBLIC WORKS	DJM
•	REV.	DATE	REVISION	BY

RAKE OR EQUIVALENT AND LIGHT TRACTOR.

NOT TO SCALE

LEVEL PRIOR TO INSTALLATION OF THE POROUS STONE MEDIA.

NOT TIE ROOF LEADERS FROM UNITS 5-8 INTO THESE SYSTEMS.

SUBSURFACE STONE INFILTRATION BED DETAIL

POND AREA

Designed and Produced in NH

85 Portsmouth Ave. Civil Engineering Services 603-772-4746 FAX: 603-772-0227 PO Box 219 E-MAIL: JBE@JONESANDBEACH.COM Stratham, NH 03885

Plan Name:	DETAIL SHEET
Project:	"GRAPEVINE RUN" 212, 214, & 216 WOODBURY AVE. PORTSMOUTH, NH 03801

FREDERICK J. BAILEY III & JOYCE S. NELSON

4 SHORE RD., WOLFEBORO, NH 03894

RESTORE THE SUBGRADE AS DIRECTED BY ENGINEER AND REPLACE CONTAMINATED SOIL

6. IN ADDITION TO DESIGN CRITERIA LISTED HERE, REFER TO GUIDELINES LISTED IN UNIVERSITY

BIORETENTION SYSTEM #2 HAS A PRETX CURB INLET STRUCTURE FOR PRE-TREATMENT.

OF NEW HAMPSHIRE (UNH) STORMWATER CENTER BIORETENTION SOIL SPECIFICATION.

7. BIORETENTION SYSTEM #1 HAS A SEDIMENT FOREBAYS FOR PRE-TREATMENT AND

MEDIA WITH NEW SOIL MEDIA.

NOT TO SCALE

BIORETENTION SYSTEM

Owner of Record:

DRAWING No. SHEET 15 OF 23 JBE PROJECT NO. 21254

ACCUMULATED SEDIMENTS OR RECONSTRUCTION OF THE

VEGETATION SHOULD BE INSPECTED AT LEAST

ANNUALLY, AND MAINTAINED IN HEALTHY CONDITION,

DEAD OR DISEASED VEGETATION, AND REMOVAL OF


INCLUDING PRUNING, REMOVAL AND REPLACEMENT OF


FILTER MEDIA.

INVASIVE SPECIES.

LOT 1: BK 4708 PG 979


LOT 2: BK 4582 PG 888

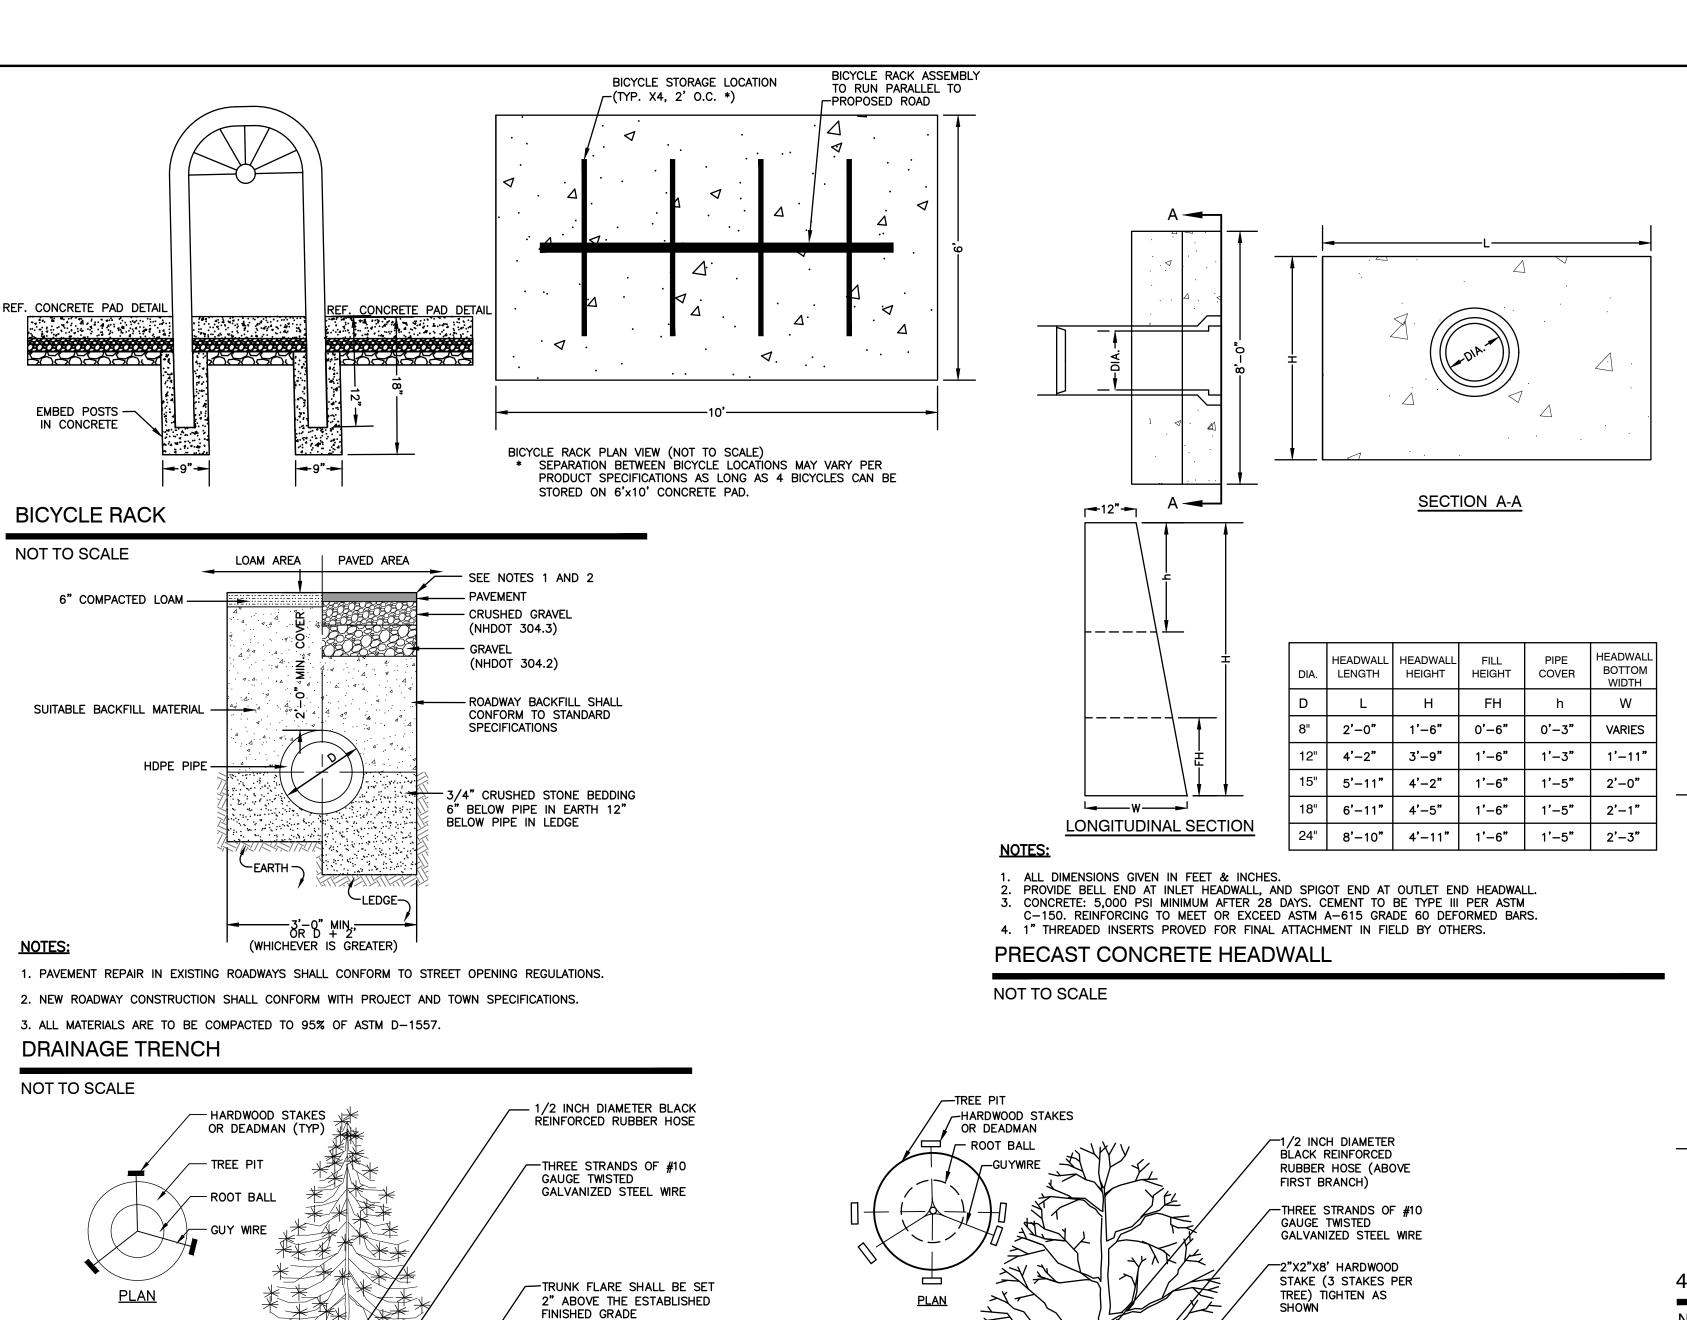


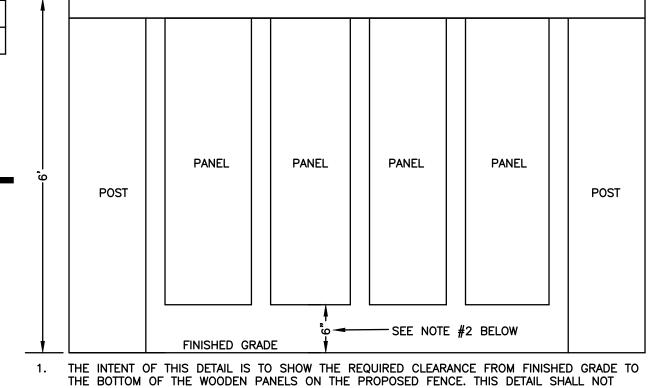

CONSTRUE A REQUIREMENT WITH REGARDS TO POST OR PANEL PLACEMENT ALONG THE LENGTH OF THE FENCE.


2. A 6" CLEARANCE MUST BE PROVIDED BETWEEN FINISHED GRADE AND THE BOTTOM OF WOODEN PANELS ON THE FENCE BEHIND BIORETENTION #2 EMERGENCY SPILLWAY. HOWEVER, 6" CLEARANCE IS NOT NECESSARY FOR THE FENCE ATOP THE "RETAINING WALL BEHIND UNIT 6.

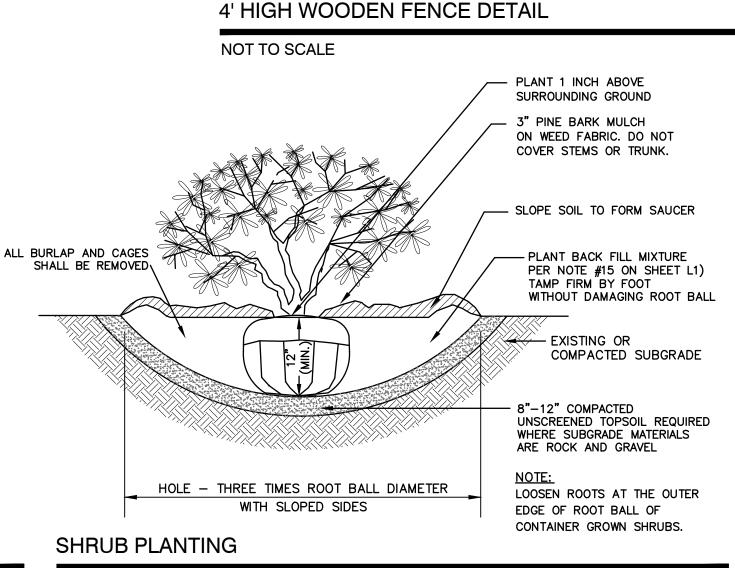

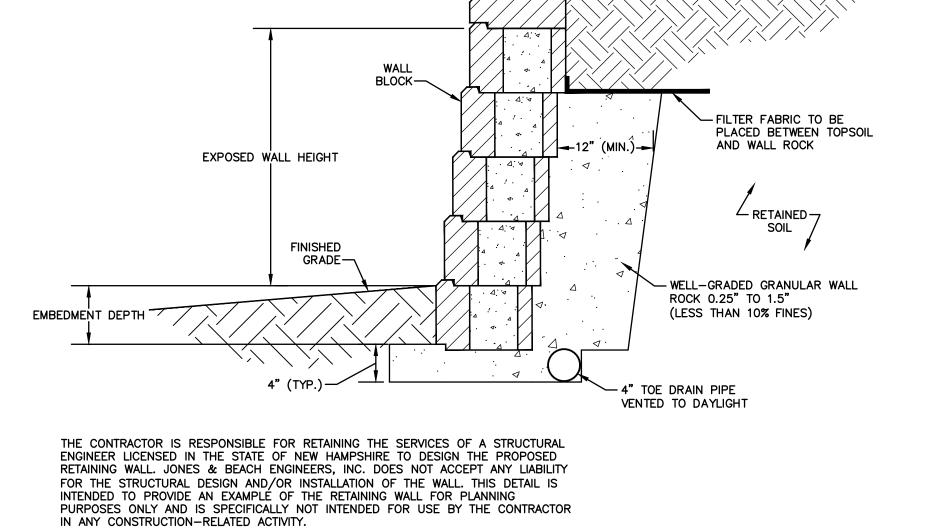

TYPICAL GRAVITY WALL DETAIL

NOT TO SCALE

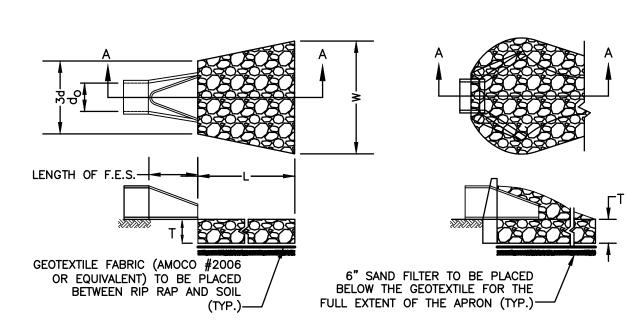

SECTION A-A PIPE OUTLET TO FLAT AREA WITH NO DEFINED CHANNEL

SECTION A-A PIPE OUTLET TO WELL-DEFINED CHANNEL

TABLE 7-24F	RECOMMENDED	RIP RAP GRAI	DATI	ON RANGES
THICKNESS OF F	RIP RAP = 1.	5 FEET		
d50 SIZE=	0.25	FEET	3	INCHES
% OF WEIGHT SM THAN THE GIVEN		SIZE OF S FROM	NOT	IE (INCHES) TO
100%		5		6
85%		4		5
50%		3		5
15%		1		2

- 1. THE SUBGRADE FOR THE GEOTEXTILE FABRIC AND RIP RAP SHALL BE PREPARED TO THE LINES AND GRADES SHOWN ON THE PLANS.
- 2. THE RIP RAP SHALL CONFORM TO THE SPECIFIED GRADATION.
- 3. GEOTEXTILE FABRICS SHALL BE PROTECTED FROM PUNCTURE OR TEARING DURING THE PLACEMENT OF THE ROCK RIP. DAMAGED AREAS IN THE FABRIC SHALL BE REPAIRED BY PLACING A PIECE OF FABRIC OVER THE DAMAGED AREA OR BY COMPLETE REPLACEMENT OF THE FABRIC. ALL OVERLAPS REQUIRED FOR REPAIRS OR JOINING TWO PIECES OF FABRIC SHALL BE A MINIMUM OF 12 INCHES.
- 4. STONE FOR THE RIP RAP MAY BE PLACED BY EQUIPMENT AND SHALL BE CONSTRUCTED TO THE FULL LAYER THICKNESS IN ONE OPERATION AND IN SUCH A MANNER AS TO PREVENT SEGREGATION OF THE
- 5. OUTLETS TO A DEFINED CHANNEL SHALL HAVE 2:1 OR FLATTER SIDE SLOPES AND SHOULD BEGIN AT THE TOP OF THE CULVERT AND TAPER DOWN TO THE CHANNEL BOTTOM THROUGH THE LENGTH OF THE
- 6. <u>MAINTENANCE</u>: THE OUTLET PROTECTION SHOULD BE CHECKED AT LEAST ANNUALLY AND AFTER EVERY MAJOR STORM. IF THE RIP RAP HAS BEEN DISPLACED, UNDERMINED OR DAMAGED, IT SHOULD BE REPAIRED IMMEDIATELY. THE CHANNEL IMMEDIATELY BELOW THE OUTLET SHOULD BE CHECKED TO SEE THAT EROSION IS NOT OCCURRING. THE DOWNSTREAM CHANNEL SHOULD BE KEPT CLEAR OF OBSTRUCTIONS SUCH AS FALLEN TREES, DEBRIS, AND SEDIMENT THAT COULD CHANGE FLOW PATTERNS AND/OR TAILWATER DEPTHS ON THE PIPES. REPAIRS MUST BE CARRIED OUT IMMEDIATELY TO AVOID ADDITIONAL DAMAGE TO OUTLET PROTECTION.

RIP RAP OUTLET PROTECTION APRON

NOT TO SCALE

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EVERGREEN PLANTING

NOT TO SCALE

HOLE - THREE TIMES ROOTBALL DIAMETER

WITH SLOPED SIDES

REMOVE ALL BURLAP

PLANT BACKFILL

ON SHEET L1.

ROOT BALL


TAMP FIRM SOIL

MIXTURE BY FOOT

WITHOUT DAMAGING

XTURE PER NOTE #15

AND CAGES-

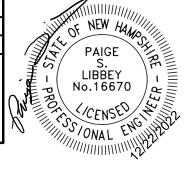

-3" PINE BARK MULCH ON

2" x 2" HARDWOOD STAKE OR

TIGHTEN AS SHOWN -

DEADMAN (3 STAKES PER TREE)

WEED FABRIC. DO NOT PLACE

FORM SAUCER

SIT ROOT BALL DIRECTLY ON

COMPACTED SUBGRADE

EXISTING OR

UNDISTURBED SOIL

MULCH WITHIN 3" OF TRUNK

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HOLE - THREE TIMES ROOTBALL DIAMETER,

WITH SLOPED SIDES

TREE PLANTING (FOR TREES UNDER 4" CALIPER)

8"-12" COMPACTED

UNSCREENED TOPSOIL

REQUIRED WHERE SUBGRADE MATERIALS

EXISTING OR COMPACTED

SUBGRADE -

NOT TO SCALE

PLANT BACK FILL MIXTURE

PER NOTE #15 ON SHEET L1. TAMP FIRM BY FOOT

WITHOUT DAMAGING ROOT BALL

ARE ROCK AND GRAVEL -

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NOT TO SCALE

TREE SHALL BE SET

SET 2" ABOVE THE

TRUNK FLARE SHALL BE

ESTABLISHED FINISHED

DIRECTLY ON UNDISTURBED

ALL BURLAP AND CAGES

SHALL BE REMOVED

GRADE. SIT ROOT BALL

PLUMB, AFTER SETTLEMENT

-3" PINE BARK

3" OF TRUNK

MULCH, DO NOT

PLACE MULCH WITHIN


-SLOPE SOIL TO FORM

3" HIGH SAUCER.

<u></u> /				•
85 Portsmouth Ave. PO Box 219	Civil	Engineering		603-772-4746 FAX: 603-772-0227
Stratham, NH 03885			E-MAIL: JBE@JC	ONESANDBEACH.COM


Plan Name:	DETAIL SHEET	
Project:	"GRAPEVINE RUN" 212, 214, & 216 WOODBURY AVE. PORTSMOUT	H, NH 03801
Owner of Record:	FREDERICK J. BAILEY III & JOYCE S. NELSON 4 SHORE RD., WOLFEBORO, NH 03894	LOT 1: BK 4708 PG 979 LOT 2: BK 4582 PG 888 LOT 3: BK 3919 PG 1345

DRAWING No. SHEET 16 OF 23 JBE PROJECT NO. 21254

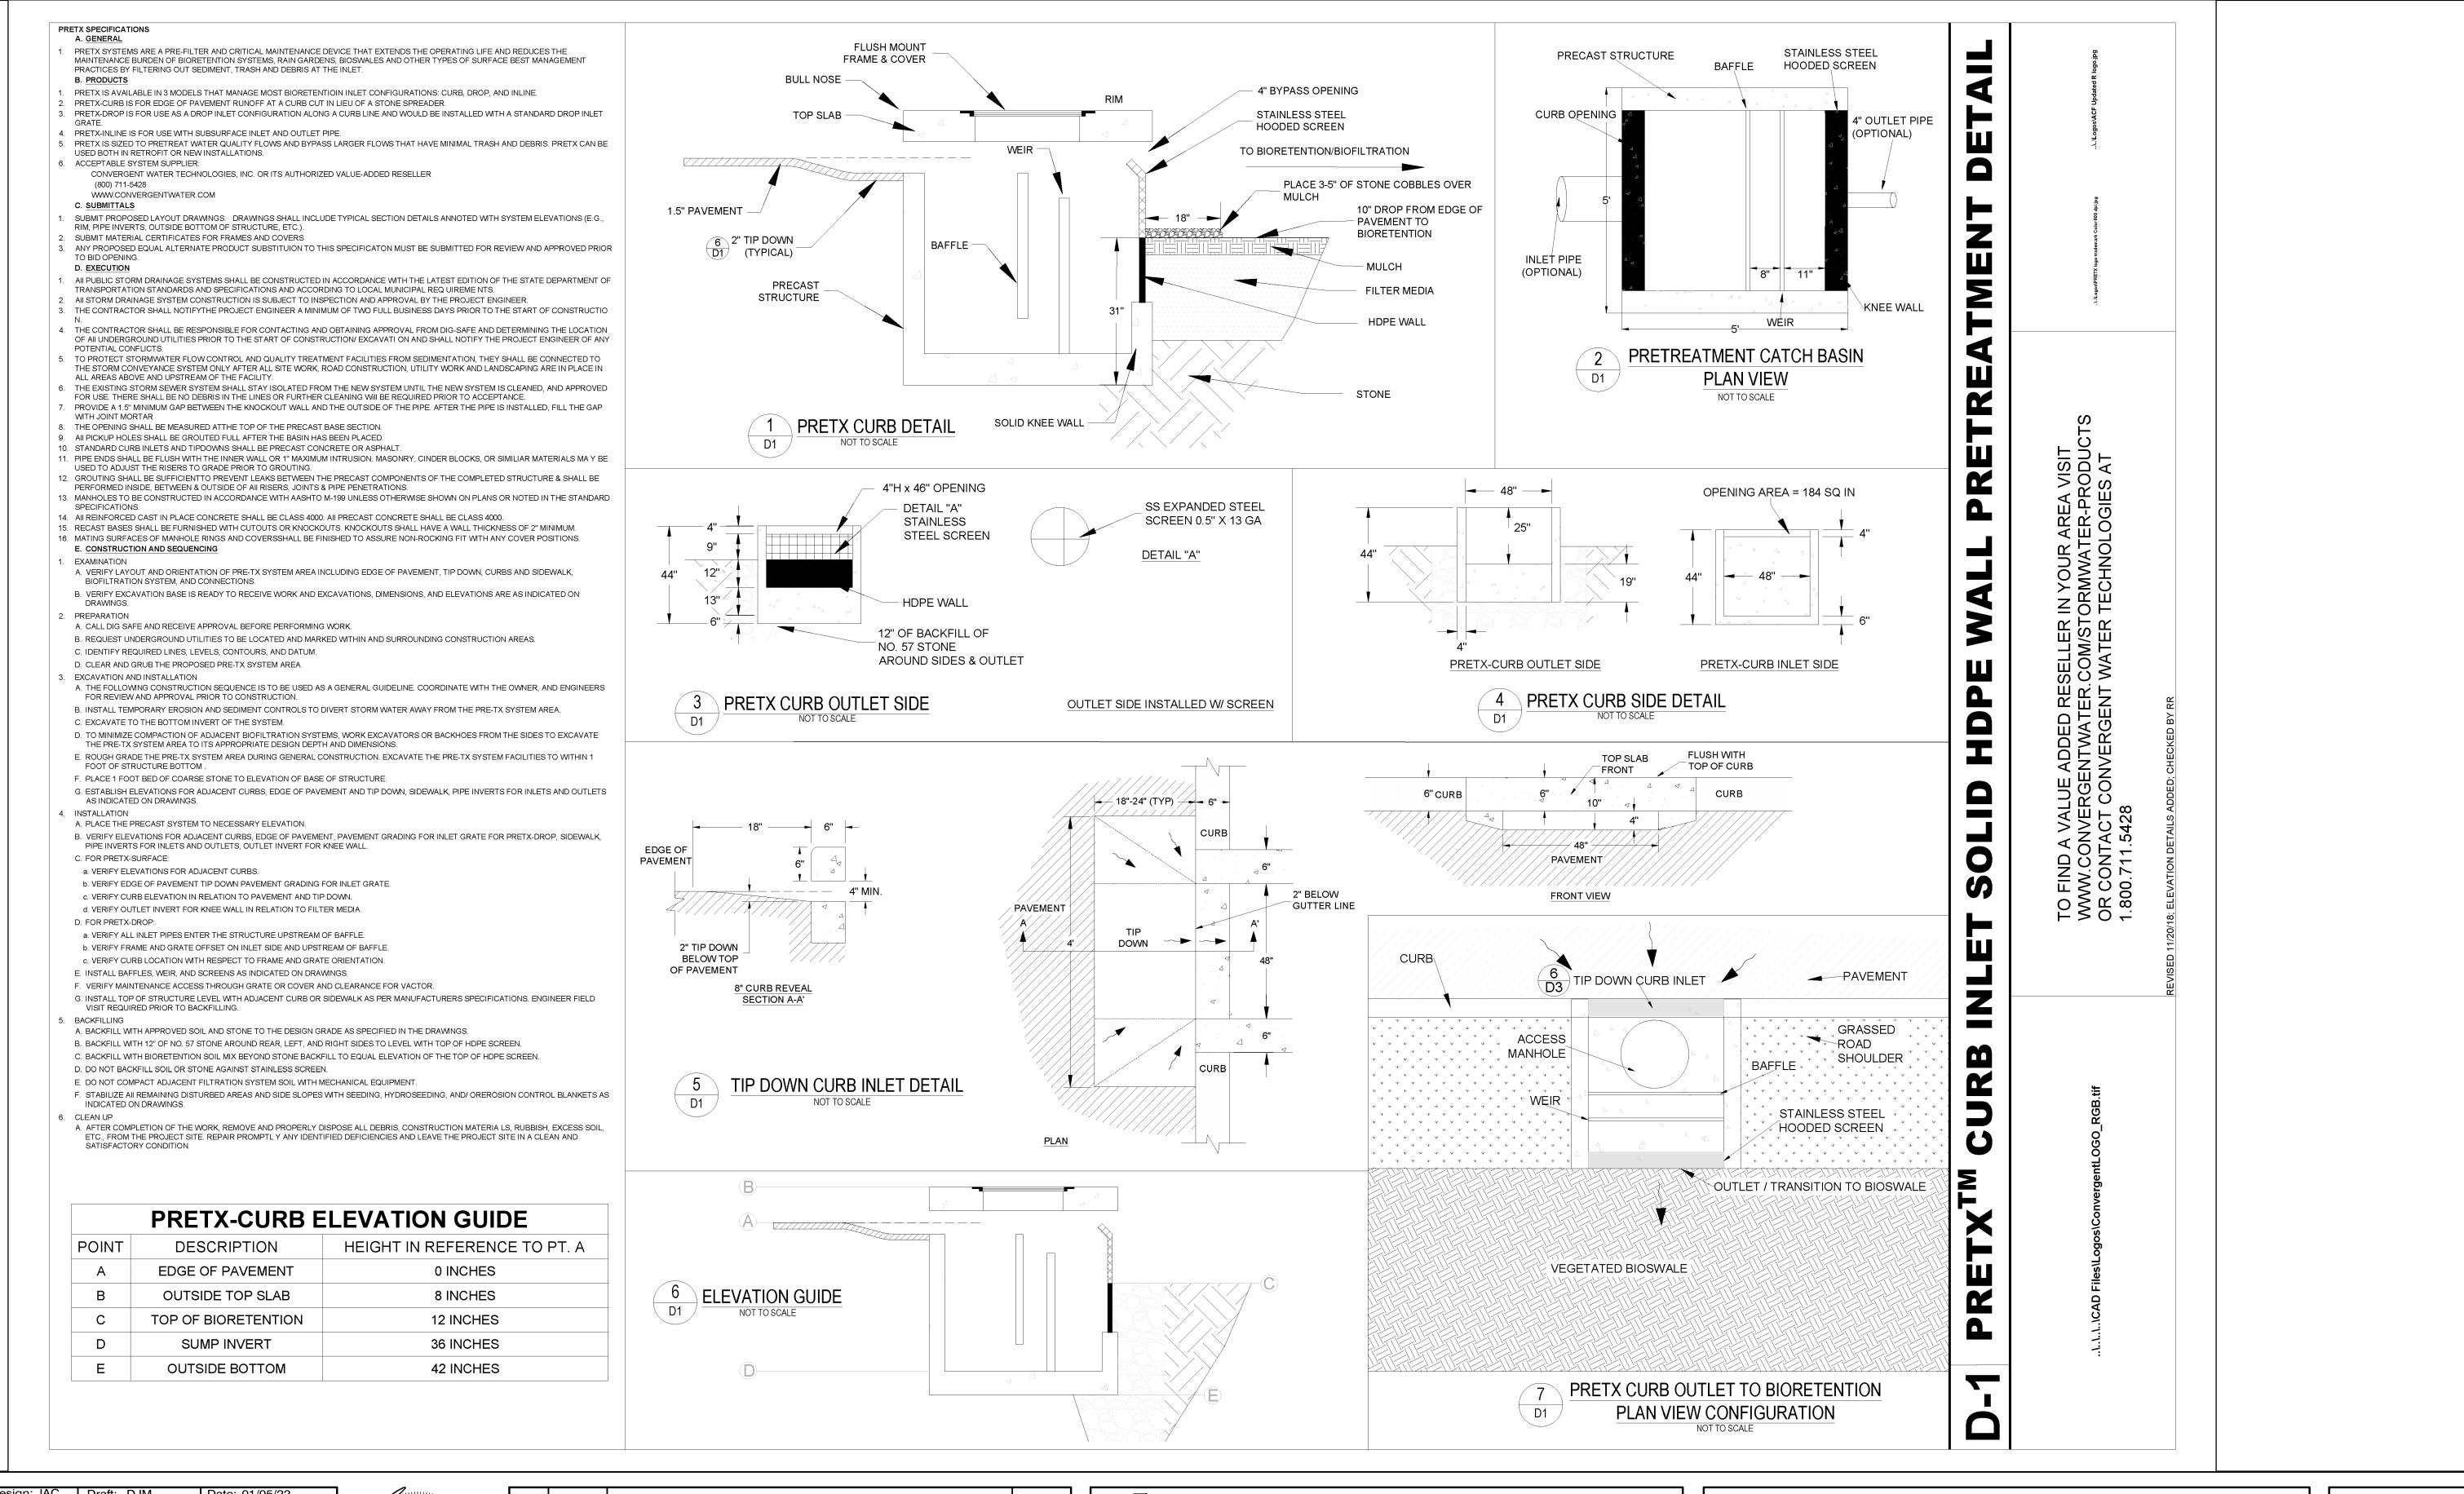

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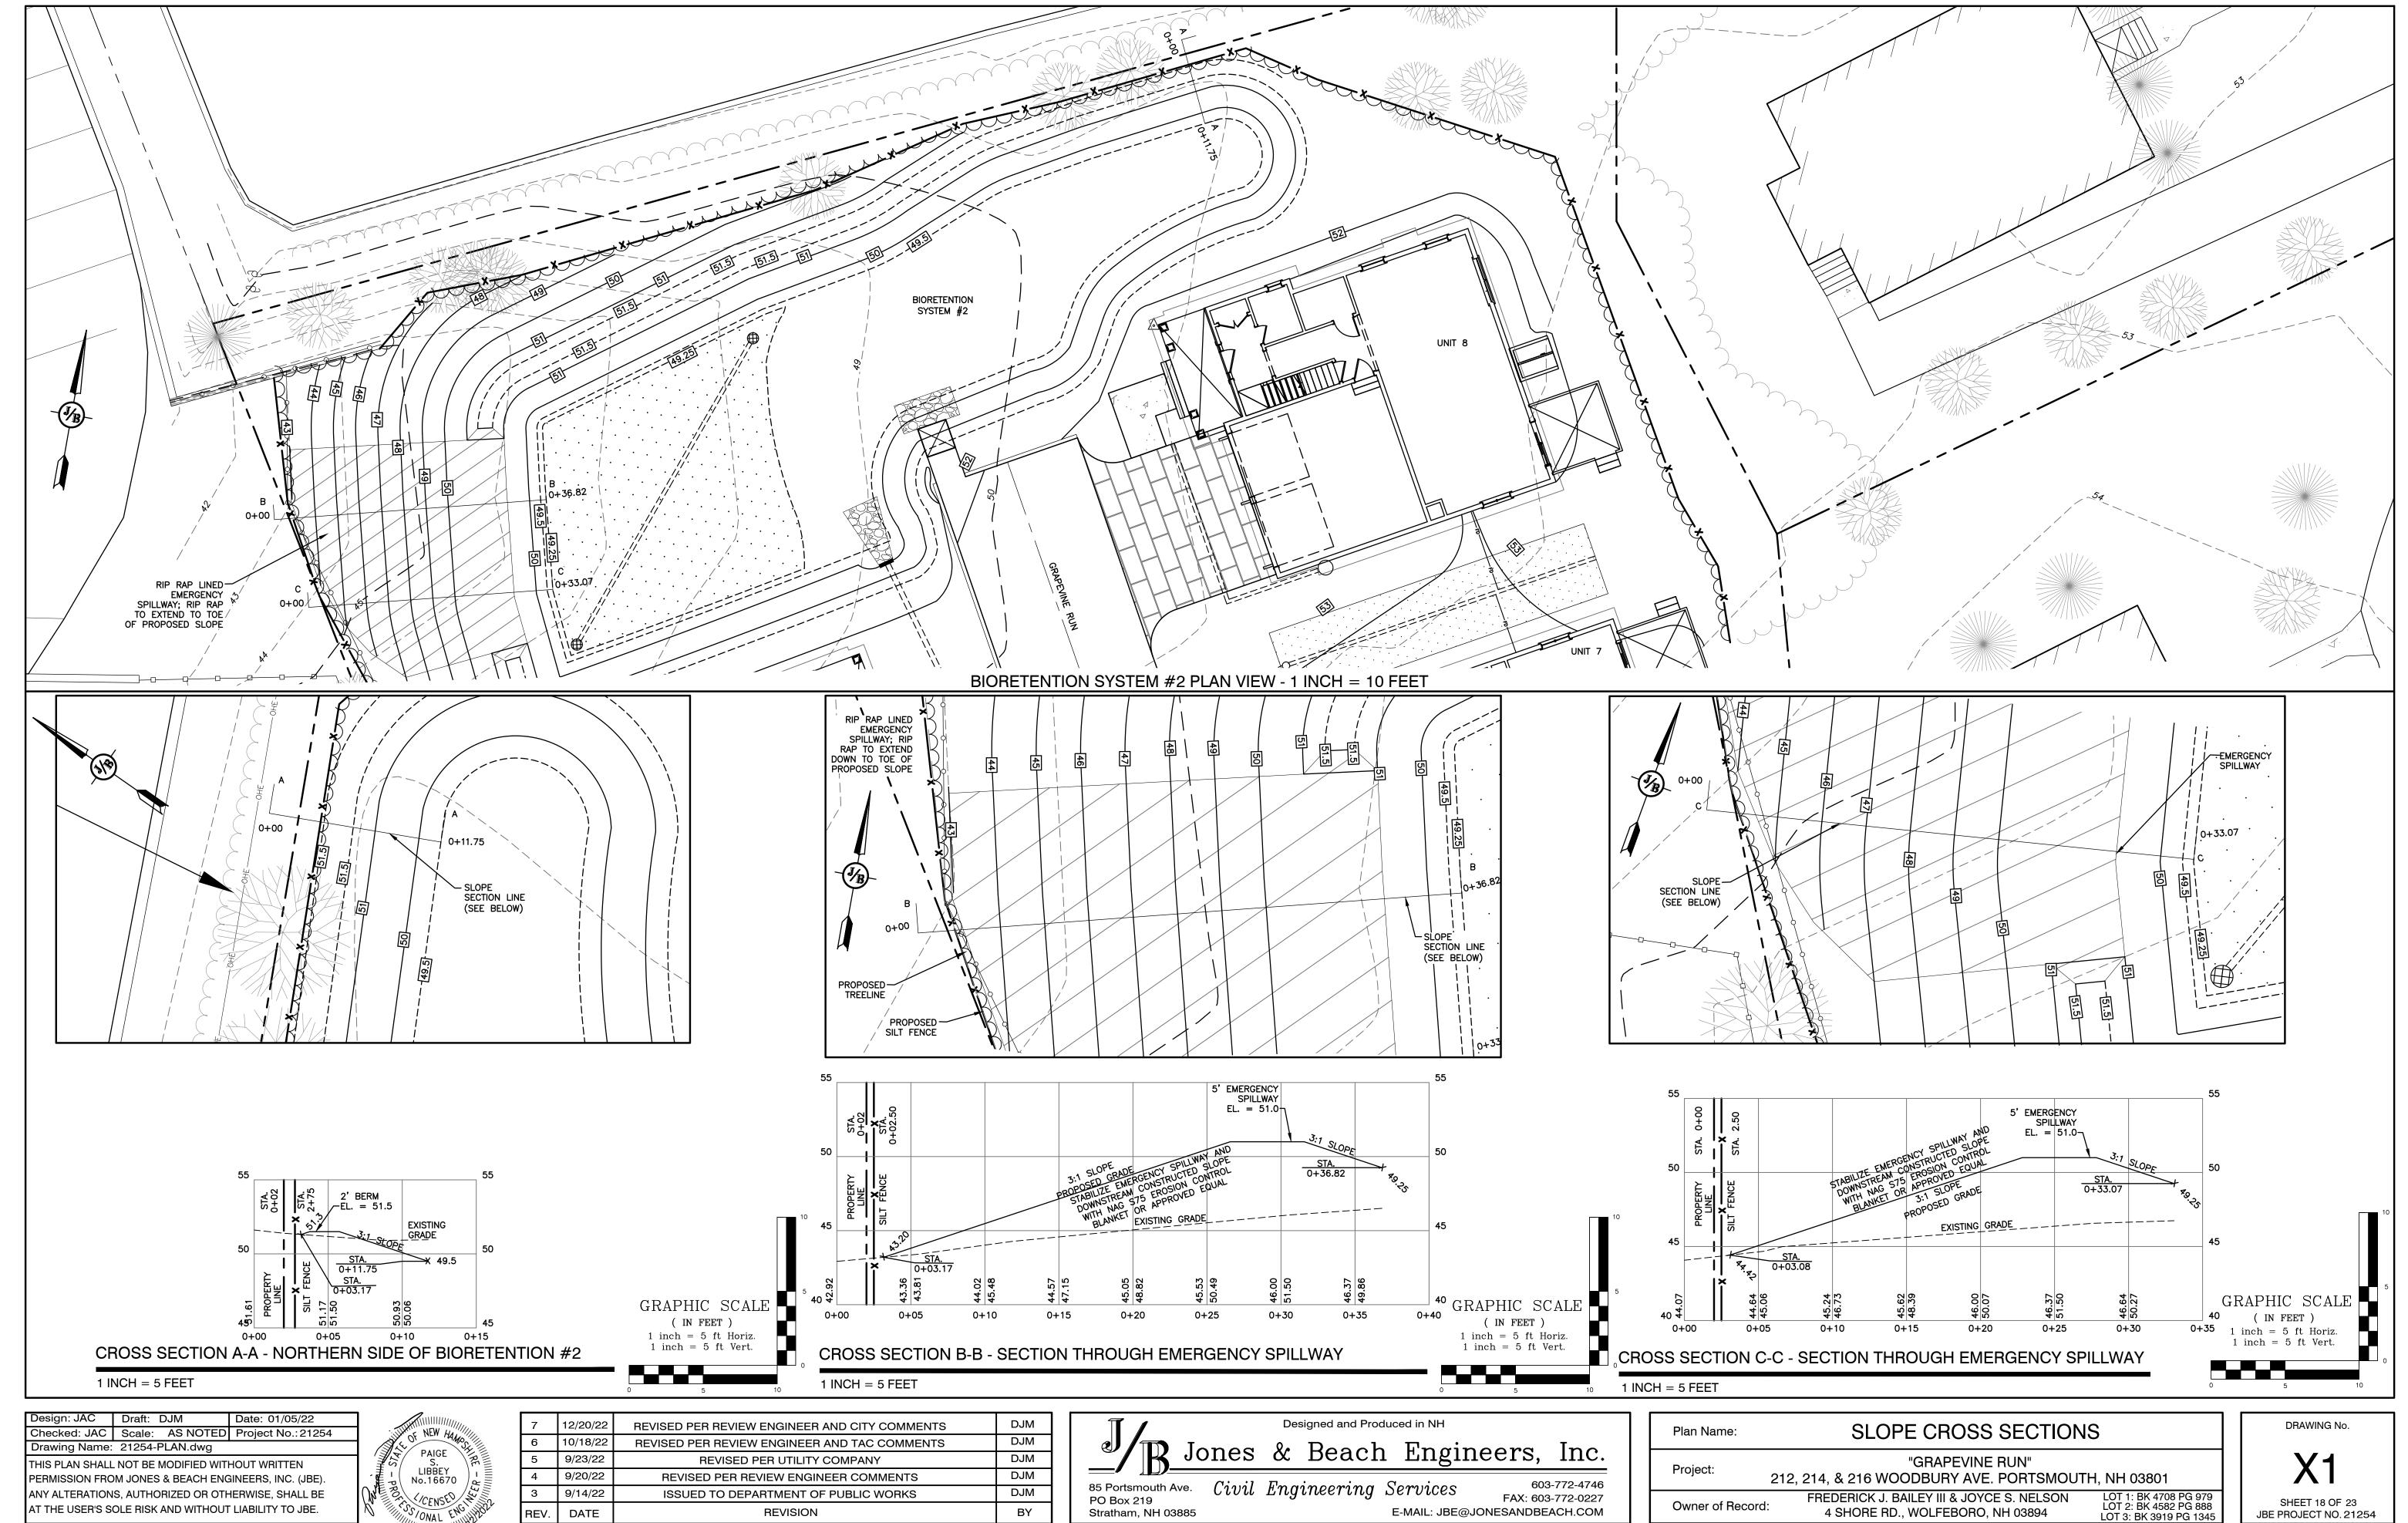
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	Engineering		603-772-4746 FAX: 603-772-0227
Stratham, NH 03885		E-MAIL: JBE@J0	ONESANDBEACH.COM

DETAIL SHEET Plan Name: "GRAPEVINE RUN" Project: 212, 214, & 216 WOODBURY AVE. PORTSMOUTH, NH 03801 LOT 1: BK 4708 PG 979 LOT 2: BK 4582 PG 888 FREDERICK J. BAILEY III & JOYCE S. NELSON Owner of Record: 4 SHORE RD., WOLFEBORO, NH 03894

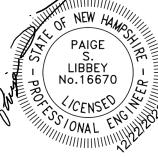



PAIGE S.
LIBBEY No.16670
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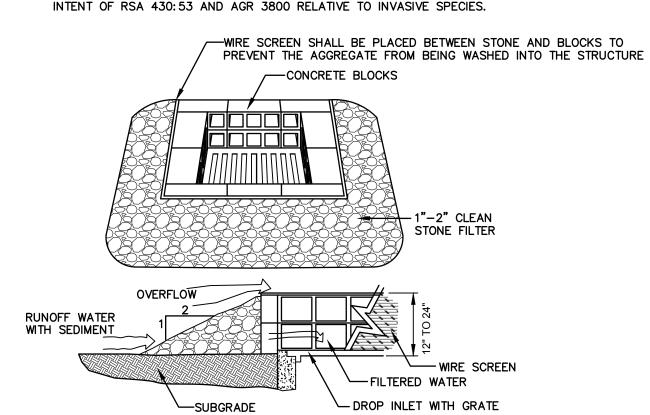
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TEMPORARY EROSION CONTROL NOTES


- 1. THE SMALLEST PRACTICAL AREA OF LAND SHALL BE EXPOSED AT ANY ONE TIME. AT NO TIME SHALL AN AREA IN EXCESS OF 5 ACRES BE EXPOSED AT ANY ONE TIME BEFORE DISTURBED AREAS ARE STABILIZED.
- EROSION, SEDIMENT AND DETENTION MEASURES SHALL BE INSTALLED AS SHOWN ON THE PLANS AND AT LOCATIONS AS REQUIRED OR DIRECTED BY
- ALL DISTURBED AREAS (INCLUDING POND AREAS BELOW THE PROPOSED WATERLINE) SHALL BE RETURNED TO PROPOSED GRADES AND ELEVATIONS. DISTURBED AREAS SHALL BE LOAMED WITH A MINIMUM OF 6" OF SCREENED ORGANIC LOAM AND SEEDED WITH SEED MIXTURE 'C' AT A RATE NOT LESS THAN 1.10 POUNDS OF SEED PER 1,000 S.F. OF AREA (48 LBS. / ACRE).
- 4. SILT FENCES AND OTHER BARRIERS SHALL BE INSPECTED EVERY SEVEN CALENDAR DAYS AND WITHIN 24 HOURS OF A RAINFALL OF 0.5" OR GREATER. ALL DAMAGED AREAS SHALL BE REPAIRED, AND SEDIMENT DEPOSITS SHALL PERIODICALLY BE REMOVED AND DISPOSED OF.
- 5. AFTER ALL DISTURBED AREAS HAVE BEEN STABILIZED, THE TEMPORARY EROSION CONTROL MEASURES SHALL BE REMOVED AND THE AREA DISTURBED BY THE REMOVAL SMOOTHED AND RE-VEGETATED.
- 6. AREAS MUST BE SEEDED AND MULCHED OR OTHERWISE PERMANENTLY STABILIZED WITHIN 3 DAYS OF FINAL GRADING, OR TEMPORARILY STABILIZED WITHIN 14 DAYS OF THE INITIAL DISTURBANCE OF SOIL. ALL AREAS SHALL BE STABILIZED WITHIN 45 DAYS OF INITIAL DISTURBANCE.
- 7. ALL PROPOSED VEGETATED AREAS THAT DO NOT EXHIBIT A MINIMUM OF 85 PERCENT VEGETATIVE GROWTH BY OCTOBER 15, OR WHICH ARE DISTURBED AFTER OCTOBER 15, SHALL BE STABILIZED BY SEEDING AND INSTALLING NORTH AMERICAN GREEN S150 EROSION CONTROL BLANKETS (OR AN EQUIVALENT APPROVED IN WRITING BY THE ENGINEER) ON SLOPES GREATER THAN 3:1, AND SEEDING AND PLACING 3 TO 4 TONS OF MULCH PER ACRE. SECURED WITH ANCHORED NETTING, ELSEWHERE. THÉ INSTALLATION OF EROSION CONTROL BLANKETS OR MULCH AND NETTING SHALL NOT OCCUR OVER ACCUMULATED SNOW OR ON FROZEN GROUND AND SHALL BE COMPLETED IN ADVANCE OF THAW OR SPRING MELT EVENTS.
- ALL DITCHES OR SWALES WHICH DO NOT EXHIBIT A MINIMUM OF 85 PERCENT VEGETATIVE GROWTH BY OCTOBER 15, OR WHICH ARE DISTURBED AFTER OCTOBER 15, SHALL BE STABILIZED TEMPORARILY WITH STONE OR EROSION CONTROL BLANKETS APPROPRIATE FOR THE DESIGN FLOW CONDITIONS.
- 9. AFTER OCTOBER 15th, INCOMPLETE ROAD OR PARKING SURFACES, WHERE WORK HAS STOPPED FOR THE WINTER SEASON, SHALL BE PROTECTED WITH A MINIMUM OF 3" OF CRUSHED GRAVEL PER NHDOT ITEM 304.3.
- 10. AN AREA SHALL BE CONSIDERED STABLE IF ONE OF THE FOLLOWING HAS OCCURRED:
 - a. BASE COURSE GRAVELS HAVE BEEN INSTALLED IN AREAS TO BE PAVED;
 - b. A MINIMUM OF 85% VEGETATED GROWTH HAS BEEN ESTABLISHED;
 - c. A MINIMUM OF 3" OF NON-EROSIVE MATERIAL SUCH STONE OR RIPRAP HAS BEEN INSTALLED; OR
- d. EROSION CONTROL BLANKETS HAVE BEEN PROPERLY INSTALLED.
- 11. FUGITIVE DUST CONTROL IS REQUIRED TO BE CONTROLLED IN ACCORDANCE WITH ENV-A 1000, AND THE PROJECT IS TO MEET THE REQUIREMENTS AND



MAINTENANCE NOTE:

1. ALL STRUCTURES SHOULD BE INSPECTED AFTER EVERY RAINFALL AND REPAIRS MADE AS NECESSARY. SEDIMENT SHOULD BE REMOVED FROM TRAPPING DEVICES AFTER THE SEDIMENT HAS REACHED A MAXIMUM OF ONE HALF THE DEPTH OF THE TRAP. THE SEDIMENT SHOULD BE DISPOSED IN A SUITABLE UPLAND AREA AND PROTECTED FROM EROSION BY EITHER STRUCTURE OR VEGETATIVE MEANS. THE TEMPORARY TRAPS SHOULD BE REMOVED AND THE AREA REPAIRED AS SOON AS THE CONTRIBUTING DRAINAGE AREA TO THE INLET HAS BEEN COMPLETELY STABILIZED.

TEMPORARY CATCH BASIN INLET PROTECTION (Block and Gravel Drop Inlet Sediment Filter)

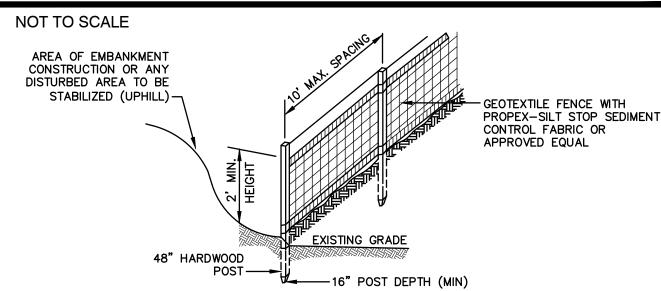

CONSTRUCTION SPECIFICATIONS:

- . WOVEN FABRIC FENCE TO BE FASTENED SECURELY TO FENCE POSTS WITH WIRE TIES OR STAPLES. FILTER CLOTH SHALL BE FASTENED TO WOVEN WIRE EVERY 24" AT TOP, MID AND BOTTOM AND EMBEDDED IN THE GROUND A MINIMUM OF 8" AND THEN COVERED WITH SOIL.
- 2. THE FENCE POSTS SHALL BE A MINIMUM OF 48" LONG, SPACED A MAXIMUM 10' APART, AND DRIVEN A MINIMUM OF 16" INTO THE GROUND.
- 3. WHEN TWO SECTIONS OF FILTER CLOTH ADJOIN EACH OTHER, THE ENDS OF THE FABRIC SHALL BE OVERLAPPED 6", FOLDED AND STAPLED TO PREVENT SEDIMENT FROM BY-PASSING.
- 4. MAINTENANCE SHALL BE PERFORMED AS NEEDED AND SEDIMENT REMOVED AND PROPERLY DISPOSED OF WHEN IT IS 6" DEEP OR VISIBLE 'BULGES' DEVELOP IN THE SILT FENCE.
- 5. PLACE THE ENDS OF THE SILT FENCE UP CONTOUR TO PROVIDE FOR SEDIMENT STORAGE.
- SILT FENCE

~ NEW HAMP! PAIGE No.16670 CENSED SIONAL

DJM 12/20/22 REVISED PER REVIEW ENGINEER AND CITY COMMENTS DJM 10/18/22 REVISED PER REVIEW ENGINEER AND TAC COMMENTS DJM 9/23/22 5 REVISED PER UTILITY COMPANY DJM 9/20/22 REVISED PER REVIEW ENGINEER COMMENTS DJM 9/14/22 ISSUED TO DEPARTMENT OF PUBLIC WORKS **REVISION** BY REV. DATE

—50' MINIMUM (75 WITHOUT MOUNTABLE BERM) → EXISTING PAVEMENT -MOUNTABLE BERM EXISTING GROUND (OPTIONAL) **WOVEN GEOTEXTILE PROFILE** FILTER FABRIC-

1. STONE FOR STABILIZED CONSTRUCTION ENTRANCE SHALL BE 3 INCH STONE, RECLAIMED STONE, OR

-50' MINIMUM (75' WITHOUT MOUNTABLE BERM)→

EXISTING

PAVEMENT :

RECYCLED CONCRETE EQUIVALENT. 2. THE LENGTH OF THE STABILIZED ENTRANCE SHALL NOT BE LESS THAN 50 FEET, 75' WITHOUT A MOUNTABLE BERM, AND EXCEPT FOR A SINGLE RESIDENTIAL LOT WHERE A 30 FOOT MINIMUM LENGTH


PLAN VIEW

- 3. THICKNESS OF THE STONE FOR THE STABILIZED ENTRANCE SHALL NOT BE LESS THAN 6 INCHES. 4. THE WIDTH OF THE ENTRANCE SHALL NOT BE LESS THAN THE FULL WIDTH OF THE ENTRANCE WHERE
- INGRESS OR EGRESS OCCURS, OR 10 FEET, WHICHEVER IS GREATER. 5. GEOTEXTILE FILTER FABRIC SHALL BE PLACED OVER THE ENTIRE AREA PRIOR TO PLACING THE STONE.
- FILTER FABRIC IS NOT REQUIRED FOR A SINGLE FAMILY RESIDENTIAL LOT. 6. ALL SURFACE WATER THAT IS FLOWING TO OR DIVERTED TOWARD THE CONSTRUCTION ENTRANCE SHALL B PIPED BENEATH THE ENTRANCE. IF PIPING IS IMPRACTICAL, A STONE BERM WITH 5:1 SLOPES THAT CAN BE
- CROSSED BY VEHICLES MAY BE SUBSTITUTED FOR THE PIPE 7. THE ENTRANCE SHALL BE MAINTAINED IN A CONDITION THAT WILL PREVENT TRACKING OR FLOWING OF SEDIMENT ONTO THE PUBLIC RIGHT-OF-WAY. THIS MAY REQUIRE PERIODIC TOP DRESSING WITH ADDITIONAL STONE AS CONDITIONS DEMAND AND REPAIR AND/OR CLEAN OUT OF ANY MEASURES USED TO TRAP SEDIMENT. ALL SEDIMENT SPILLED, WASHED, OR TRACKED ONTO THE PUBLIC RIGHT—OF—WAY MUST BE

STABILIZED CONSTRUCTION ENTRANCE

NOT TO SCALE

REMOVED PROMPTLY.

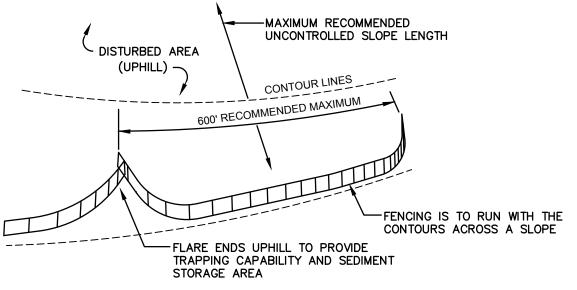

7. SILT FENCES SHALL BE REMOVED WHEN NO LONGER NEEDED AND THE SEDIMENT COLLECTED SHALL BE DISPOSED AS DIRECTED BY THE ENGINEER. THE AREA DISTURBED BY THE REMOVAL SHALL BE SMOOTHED AND REVEGETATED.

<u>MAINTENANCE:</u>

- 1. SILT FENCES SHALL BE INSPECTED IMMEDIATELY AFTER EACH RAINFALL AND AT LEAST DAILY DURING PROLONGED RAINFALL. ANY REPAIRS THAT ARE REQUIRED SHALL BE DONE IMMEDIATELY.
- 2. IF THE FABRIC ON A SILT FENCE SHOULD DECOMPOSE OR BECOME INEFFECTIVE DURING THE EXPECTED LIFE OF THE FENCE, THE FABRIC SHALL BE REPLACED PROMPTLY.
- 3. SEDIMENT DEPOSITS SHOULD BE INSPECTED AFTER EVERY STORM EVENT. THE DEPOSITS SHOULD BE REMOVED WHEN THEY REACH APPROXIMATELY ONE HALF THE HEIGHT OF THE BARRIER.
- 4. SEDIMENT DEPOSITS THAT ARE REMOVED, OR LEFT IN PLACE AFTER THE FABRIC HAS BEEN REMOVED, SHALL BE GRADED TO CONFORM WITH THE EXISTING TOPOGRAPHY AND VEGETATED.

SEEDING SPECIFICATIONS

- 1. GRADING AND SHAPING A. SLOPES SHALL NOT BE STEEPER THAN 2:1 WITHOUT APPROPRIATE EROSION CONTROL MEASURES AS
- SPECIFIED ON THE PLANS (3:1 SLOPES OR FLATTER ARE PREFERRED). B. WHERE MOWING WILL BE DONE, 3:1 SLOPES OR FLATTER ARE RECOMMENDED.

2. <u>SEEDBED PREPARATION</u>

- A. SURFACE AND SEEPAGE WATER SHOULD BE DRAINED OR DIVERTED FROM THE SITE TO PREVENT DROWNING OR WINTER KILLING OF THE PLANTS.
- B. STONES LARGER THAN 4 INCHES AND TRASH SHOULD BE REMOVED BECAUSE THEY INTERFERE WITH SEEDING AND FUTURE MAINTENANCE OF THE AREA. WHERE FEASIBLE, THE SOIL SHOULD BE TILLED TO A DEPTH OF ABOUT 4 INCHES TO PREPARE A SEEDBED AND FERTILIZER AND LIME MIXED INTO THE SOIL. THE SEEDBED SHOULD BE LEFT IN A REASONABLY FIRM AND SMOOTH CONDITION. THE LAST TILLAGE OPERATION SHOULD BE PERFORMED ACROSS THE SLOPE WHEREVER PRACTICAL.

3. ESTABLISHING A STAND

- A. LIME AND FERTILIZER SHOULD BE APPLIED PRIOR TO OR AT THE TIME OF SEEDING AND INCORPORATED INTO THE SOIL. TYPES AND AMOUNTS OF LIME AND FERTILIZER SHOULD BE BASED ON AN EVALUATION OF SOIL TESTS. WHEN A SOIL TEST IS NOT AVAILABLE, THE FOLLOWING MINIMUM AMOUNTS SHOULD BE
- AGRICULTURAL LIMESTONE, 2 TONS PER ACRE OR 100 LBS. PER 1,000 SQ.FT.
- NITROGEN(N), 50 LBS. PER ACRE OR 1.1 LBS. PER 1,000 SQ.FT. PHOSPHATE(P205), 100 LBS. PER ACRE OR 2.2 LBS. PER 1,000 SQ.FT.
- POTASH(K20), 100 LBS. PER ACRE OR 2.2 LBS. PER 1,000 SQ.FT. (NOTE: THIS IS THE EQUIVALENT OF 500 LBS. PER ACRE OF 10-20-20 FERTILIZER OR 1,000 LBS. PER
- ACRE OF 5-10-10.) B. SEED SHOULD BE SPREAD UNIFORMLY BY THE METHOD MOST APPROPRIATE FOR THE SITE. METHODS INCLUDE BROADCASTING, DRILLING AND HYDROSEEDING. WHERE BROADCASTING IS USED, COVER SEED WITH
- .25 INCH OF SOIL OR LESS, BY CULTIPACKING OR RAKING. C. REFER TO THE 'SEEDING GUIDE' AND 'SEEDING RATES' TABLES ON THIS SHEET FOR APPROPRIATE SEED MIXTURES AND RATES OF SEEDING. ALL LEGUMES (CROWNVETCH, BIRDSFOOT, TREFOIL AND FLATPEA)
- MUST BE INOCULATED WITH THEIR SPECIFIC INOCULANT PRIOR TO THEIR INTRODUCTION TO THE SITE. D. WHEN SEEDED AREAS ARE MULCHED, PLANTINGS MAY BE MADE FROM EARLY SPRING TO EARLY OCTOBER. WHEN SEEDED AREAS ARE NOT MULCHED, PLANTINGS SHOULD BE MADE FROM EARLY SPRING TO MAY 20th OR FROM AUGUST 10th TO SEPTEMBER 1st.

A. HAY, STRAW, OR OTHER MULCH, WHEN NEEDED, SHOULD BE APPLIED IMMEDIATELY AFTER SEEDING. B. MULCH WILL BE HELD IN PLACE USING APPROPRIATE TECHNIQUES FROM THE BEST MANAGEMENT PRACTICE FOR MULCHING. HAY OR STRAW MULCH SHALL BE PLACED AT A RATE OF 90 LBS PER 1000 S.F.

5. MAINTENANCE TO ESTABLISH A STAND

- A. PLANTED AREAS SHOULD BE PROTECTED FROM DAMAGE BY FIRE, GRAZING, TRAFFIC, AND DENSE WEED
- B. FERTILIZATION NEEDS SHOULD BE DETERMINED BY ONSITE INSPECTIONS. SUPPLEMENTAL FERTILIZER IS USUALLY THE KEY TO FULLY COMPLETE THE ESTABLISHMENT OF THE STAND BECAUSE MOST PERENNIALS TAKE 2 TO 3 YEARS TO BECOME FULLY ESTABLISHED.
- C. IN WATERWAYS, CHANNELS, OR SWALES WHERE UNIFORM FLOW CONDITIONS ARE ANTICIPATED, ANNUAL MOWING MAY BE NECESSARY TO CONTROL GROWTH OF WOODY VEGETATION.

USE	SEEDING MIXTURE 1/	DROUGHTY	WELL DRAINED	MODERATELY WELL DRAINED	POORLY DRAINED
STEEP CUTS AND FILLS, BORROW AND DISPOSAL AREAS	A B C	FAIR POOR POOR FAIR	GOOD GOOD GOOD EXCELLENT	GOOD FAIR EXCELLENT EXCELLENT	FAIR FAIR GOOD POOR
WATERWAYS, EMERGENC' SPILLWAYS, AND OTHER CHANNELS WITH FLOWING WATER.		GOOD GOOD	GOOD EXCELLENT	GOOD EXCELLENT	FAIR FAIR
LIGHTLY USED PARKING LOTS, ODD AREAS, UNUSED LANDS, AND LOW INTENSITY USE RECREATION SITES.	A B C	GOOD GOOD GOOD	GOOD GOOD EXCELLENT	GOOD FAIR EXCELLENT	FAIR POOR FAIR
PLAY AREAS AND ATHLETIC FIELDS. (TOPSOIL IS ESSENTIAL FOR GOOD TURF.)	E F	FAIR FAIR	EXCELLENT EXCELLENT	EXCELLENT EXCELLENT	<u>2/</u> 2/

GRAVEL PIT, SEE NH-PM-24 IN APPENDIX FOR RECOMMENDATION REGARDING RECLAMATION OF SAND AND GRAVEL PITS.

/ REFER TO SEEDING MIXTURES AND RATES IN TABLE BELOW.


2/ POORLY DRAINED SOILS ARE NOT DESIRABLE FOR USE AS PLAYING AREA AND ATHLETIC FIELDS.

NOTE: TEMPORARY SEED MIX FOR STABILIZATION OF TURF SHALL BE WINTER RYE OR OATS AT A RATE OF 2.5 LBS. PER 1000 S.F. AND SHALL BE PLACED PRIOR TO OCTOBER 15th, IF PERMANENT SEEDING NOT YET COMPLETE.

SEEDING GUIDE

	MIXTURE	POUNDS PER ACRE	POUNDS PER 1.000 Sq. Ft
*	A. TALL FESCUE CREEPING RED FESCUE RED TOP TOTAL	20 20 <u>2</u> 42	0.45 0.45 <u>0.05</u> 0.95
	B. TALL FESCUE CREEPING RED FESCUE CROWN VETCH OR	15 10 15	0.35 0.25 0.35
	FLAT PEA TOTAL	30 40 OR 55	0.75 0.95 OR 1.35
	C. TALL FESCUE CREEPING RED FESCUE BIRDS FOOT TREFOIL TOTAL	20 20 <u>8</u> 48	0.45 0.45 <u>0.20</u> 1.10
	D. TALL FESCUE FLAT PEA TOTAL	20 <u>30</u> 50	0.45 <u>0.75</u> 1.20
	E. CREEPING RED FESCUE 1/ KENTUCKY BLUEGRASS 1/ TOTAL	50 50 100	1.15 1.15 2.30
	F. TALL FESCUE 1	150	3.60
	1/FOR HEAVY USE ATHLETIC FIELDS NEW HAMPSHIRE COOPERATIVE EXTENCURRENT VARIETIES AND SEEDING RA	SION TURF SPE	

SEEDING RATES

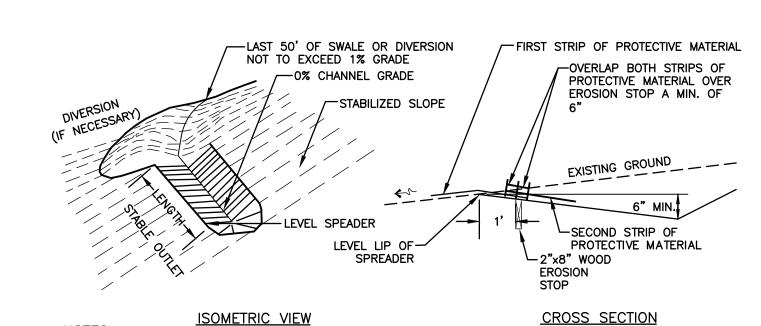

1. CONSTRUCT THE LEVEL SPREADER LIP ON A ZERO PERCENT GRADE TO ENSURE UNIFORM SPREADING

2. LEVEL SPREADER SHALL BE CONSTRUCTED ON UNDISTURBED SOIL AND NOT ON FILL.

- 3. AN EROSION STOP SHALL BE PLACED VERTICALLY A MINIMUM OF SIX INCHES DEEP IN A SLIT TRENCH ONE FOOT BACK OF THE LEVEL LIP AND PARALLEL TO THE LIP. THE EROSION STOP SHALL EXTEND THE ENTIRE LENGTH OF THE LEVEL LIP.
- 4. ENTIRE LEVEL LIP AREA SHALL BE PROTECTED BY PLACING TWO STRIPS OF JUTE OR EXCELSION MATTING ALONG THE LIP. EACH STRIP SHALL OVERLAP THE EROSION STOP BY AT LEAST SIX INCHES.
- 5. ENTRANCE CHANNEL TO THE LEVEL SPREADER SHALL NOT EXCEED A 1 PERCENT GRADE FOR AT
- 6. THE FLOW FROM THE LEVEL SPREADER SHALL OUTLET ONTO STABILIZED AREAS, WATER MUST NOT RECONCENTRATE IMMEDIATELY BELOW THE SPREADER.
- 7. PERIODIC INSPECTION AND REQUIRED MAINTENANCE SHALL BE PERFORMED.

LEAST 50 FEET BEFORE ENTERING THE SPREADER.

8. MAINTENANCE: THE LEVEL SPREADER SHOULD BE CHECKED PERIODICALLY AND AFTER EVERY MAJOR STORM TO DETERMINE IF THE SPREADER HAS BEEN DAMAGED. SEDIMENT DEEPER THAN 4" ACCUMULATION SHOULD BE REMOVED. IF RILLING HAS TAKEN PLACE ON THE LIP, THEN THE DAMAGE SHOULD BE REPAIRED AND REVEGETATED. THE VEGETATION SHOULD BE MOWED OCCASIONALLY TO CONTROL WEEDS AND THE ENCROACHMENT OF WOODY VEGETATION. CLIPPINGS SHOULD BE REMOVED AND DISPOSED OF OUTSIDE THE SPREADER AND AWAY FROM OUTLET AREA. FERTILIZATION SHOULD BE DONE AS NECESSARY TO KEEP THE VEGETATION HEALTHY AND DENSE.

LEVEL SPREADER

NOT TO SCALE

CONSTRUCTION SEQUENCE

- PRIOR TO THE START OF ANY ACTIVITY, IT IS THE RESPONSIBILITY OF THE SITE'S SITE DEVELOPER (OR OWNER) TO FILE A NOTICE OF INTENT (NOI) FORM WITH THE ENVIRONMENTAL PROTECTION AGENCY (EPA) IN ORDER TO GAIN COVERAGE UNDER THE NPDES GENERAL PERMIT FOR STORM WATER DISCHARGES FROM CONSTRUCTION ACTIVITIES. A PRE CONSTRUCTION MEETING IS TO BE HELD WITH ALL DEPARTMENT HEADS PRIOR TO THE START OF CONSTRUCTION.
- 2. CUT AND REMOVE TREES IN CONSTRUCTION AREA AS REQUIRED OR DIRECTED.
- INSTALL SILT FENCING, HAY BALES AND CONSTRUCTION ENTRANCES PRIOR TO THE START OF CONSTRUCTION. THESE ARE TO BE MAINTAINED UNTIL THE FINAL PAVEMENT SURFACING AND LANDSCAPING AREAS ARE ESTABLISHED.
- 4. CLEAR, CUT, GRUB AND DISPOSE OF DEBRIS IN APPROVED FACILITIES. THIS INCLUDES ANY REQUIRED DEMOLITION OF EXISTING STRUCTURES, UTILITIES, ETC.
- CONSTRUCT AND/OR INSTALL TEMPORARY OR PERMANENT SEDIMENT AND/OR DETENTION BASIN(S) AS REQUIRED. THESE FACILITIES SHALL BE INSTALLED AND STABILIZED PRIOR TO DIRECTING RUN-OFF TO THEM.
- STRIP LOAM AND PAVEMENT, OR RECLAIM EXISTING PAVEMENT WITHIN LIMITS OF WORK PER THE RECOMMENDATIONS OF THE PROJECT ENGINEER AND STOCKPILE EXCESS MATERIAL. STABILIZE STOCKPILE AS NECESSARY.
- 7. PERFORM PRELIMINARY SITE GRADING IN ACCORDANCE WITH THE PLANS.
- 8. PREPARE BUILDING PAD(S) TO ENABLE BUILDING CONSTRUCTION TO BEGIN.
- INSTALL THE SEWER AND DRAINAGE SYSTEMS FIRST, THEN ANY OTHER UTILITIES IN ACCORDANCE WITH THE PLAN AND DETAILS. ANY CONFLICTS BETWEEN UTILITIES ARE TO BE RESOLVED WITH THE INVOLVEMENT AND APPROVAL OF THE ENGINEER.
- 10. INSTALL INLET PROTECTION AT ALL CATCH BASINS AS THEY ARE CONSTRUCTED IN ACCORDANCE WITH DETAILS.
- 11. ALL SWALES AND DRAINAGE STRUCTURES ARE TO BE CONSTRUCTED AND STABILIZED PRIOR TO HAVING RUN-OFF DIRECTED TO THEM.
- 12. DAILY, OR AS REQUIRED, CONSTRUCT TEMPORARY BERMS, DRAINAGE DITCHES, CHECK DAMS, SEDIMENT TRAPS, ETC., TO PREVENT EROSION ON THE SITE AND PREVENT ANY SILTATION OF ABUTTING WATERS AND/OR PROPERTY.
- 13. PERFORM FINAL FINE GRADING, INCLUDING PLACEMENT OF 'SELECT' SUBGRADE MATERIALS.
- 14. PAVE ROADWAY AND DRIVEWAYS WITH INITIAL 'BASE COURSE'.
- 15. PERFORM ALL REMAINING SITE CONSTRUCTION (i.e. BUILDING, CURBING, UTILITY CONNECTIONS, ETC.).
- 16. LOAM AND SEED ALL DISTURBED AREAS AND INSTALL ANY REQUIRED SEDIMENT AND EROSION CONTROL FACILITIES (i.e. RIP RAP, EROSION CONTROL BLANKETS, ETC.).
- 17. FINISH PAVING ROADWAY AND DRIVEWAYS WITH 'FINISH' COURSE.
- 18. ROADWAY AND DRIVEWAYS SHALL BE STABILIZED WITHIN 72 HOURS OF ACHIEVING FINISHED GRADE.
- 19. ALL CUT AND FILL SLOPES SHALL BE SEEDED/LOAMED WITHIN 72 HOURS OF ACHIEVING FINISHED GRADE.
- 20. COMPLETE PERMANENT SEEDING AND LANDSCAPING.
- 21. REMOVE TEMPORARY EROSION CONTROL MEASURES AFTER SEEDING AREAS HAVE BEEN 75%-85% ESTABLISHED AND SITE IMPROVEMENTS ARE COMPLETE. SMOOTH AND RE-VEGETATE ALL DISTURBED AREAS.
- 22. CLEAN SITE AND ALL DRAINAGE STRUCTURES, PIPES AND SUMPS OF ALL SILT AND DEBRIS.
- 23. INSTALL ALL PAINTED PAVEMENT MARKINGS AND SIGNAGE PER THE PLANS AND DETAILS.
- 24. ALL EROSION CONTROLS SHALL BE INSPECTED WEEKLY AND AFTER EVERY HALF-INCH OF RAINFALL.
- 25. UPON COMPLETION OF CONSTRUCTION, IT IS THE RESPONSIBILITY OF THE CONTRACTOR TO NOTIFY ANY RELEVANT PERMITTING
- AGENCIES THAT THE CONSTRUCTION HAS BEEN FINISHED IN A SATISFACTORY MANNER.

EROSION AND SEDIMENT CONTROL DETAILS "GRAPEVINE RUN" Project:

SHEET 19 OF 23

DRAWING No.

Designed and Produced in NH

Civil Engineering Services 603-772-4746 85 Portsmouth Ave. FAX: 603-772-0227 PO Box 219 E-MAIL: JBE@JONESANDBEACH.COM Stratham, NH 03885

212, 214, & 216 WOODBURY AVE. PORTSMOUTH, NH 03801 LOT 1: BK 4708 PG 979 LOT 2: BK 4582 PG 888 FREDERICK J. BAILEY III & JOYCE S. NELSON Owner of Record: 4 SHORE RD., WOLFEBORO, NH 03894 LOT 3: BK 3919 PG 1345

JBE PROJECT NO. 21254


NOT TO SCALE Design: JAC Draft: DJM Date: 01/05/22 hecked: JAC | Scale: AS NOTED | Project No.: 21254 Drawing Name: 21254-PLAN.dwg THIS PLAN SHALL NOT BE MODIFIED WITHOUT WRITTEN

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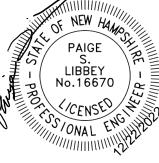
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6. SILT FENCE SHALL REMAIN IN PLACE FOR 24 MONTHS.



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7	12/20/22	REVISED PER REVIEW ENGINEER AND CITY COMMENTS	DJM
6	10/18/22	REVISED PER REVIEW ENGINEER AND TAC COMMENTS	DJM
5	9/23/22	REVISED PER UTILITY COMPANY	DJM
4	9/20/22	REVISED PER REVIEW ENGINEER COMMENTS	DJM
3	9/14/22	ISSUED TO DEPARTMENT OF PUBLIC WORKS	DJM
REV.	DATE	REVISION	BY

Designed and Produced in NH Jones & Beach Engineers, Inc. 85 Portsmouth Ave. Civil Engineering Services
PO Box 219
Stratham, NH 03885

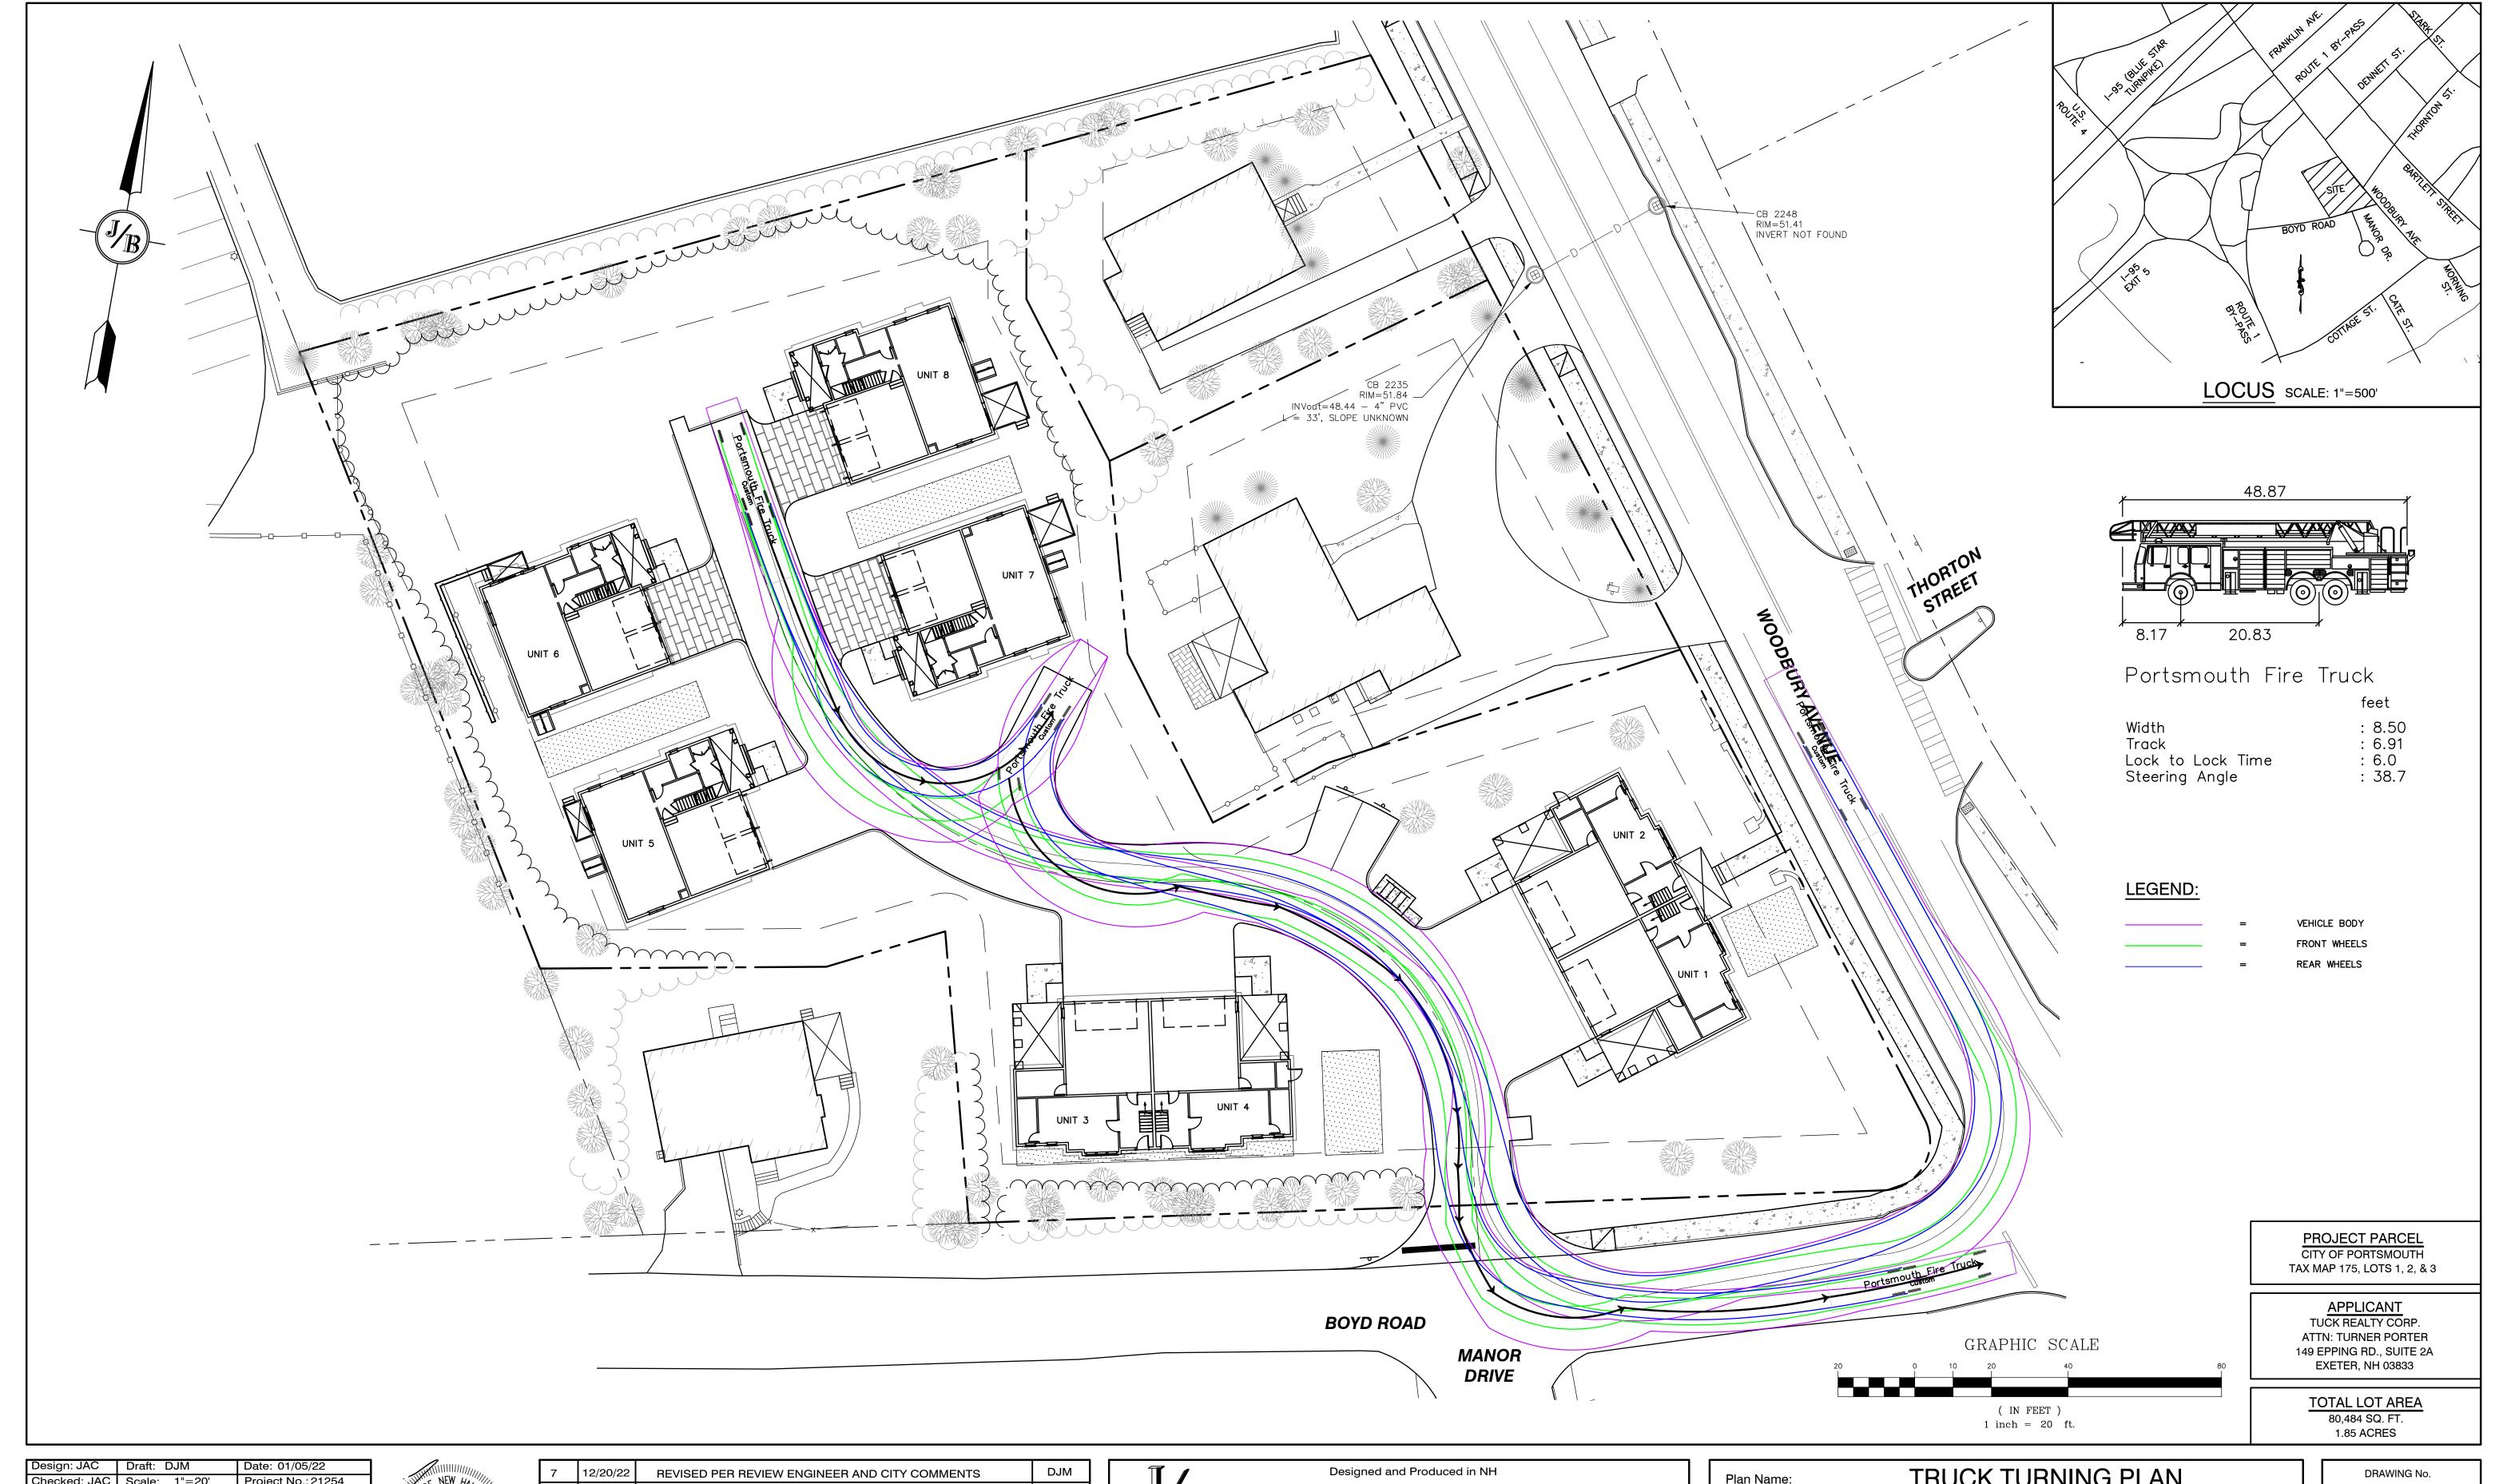E-MAIL: JBE@C 603-772-4746 FAX: 603-772-0227

E-MAIL: JBE@JONESANDBEACH.COM


Fian Name.	THOOK TORNING FLA	IN
Project:	"GRAPEVINE RUN" 212, 214, & 216 WOODBURY AVE. PORTSMOUTH	H, NH 03801
Owners of Recor	d: FREDERICK J. BAILEY III & JOYCE S. NELSON 4 SHORE RD., WOLFEBORO, NH 03894	LOT 1: BK 4708 PG 979 LOT 2: BK 4582 PG 888 LOT 3: BK 3919 PG 1345

DRAWING No. SHEET 20 OF 23 JBE PROJECT NO. 21254



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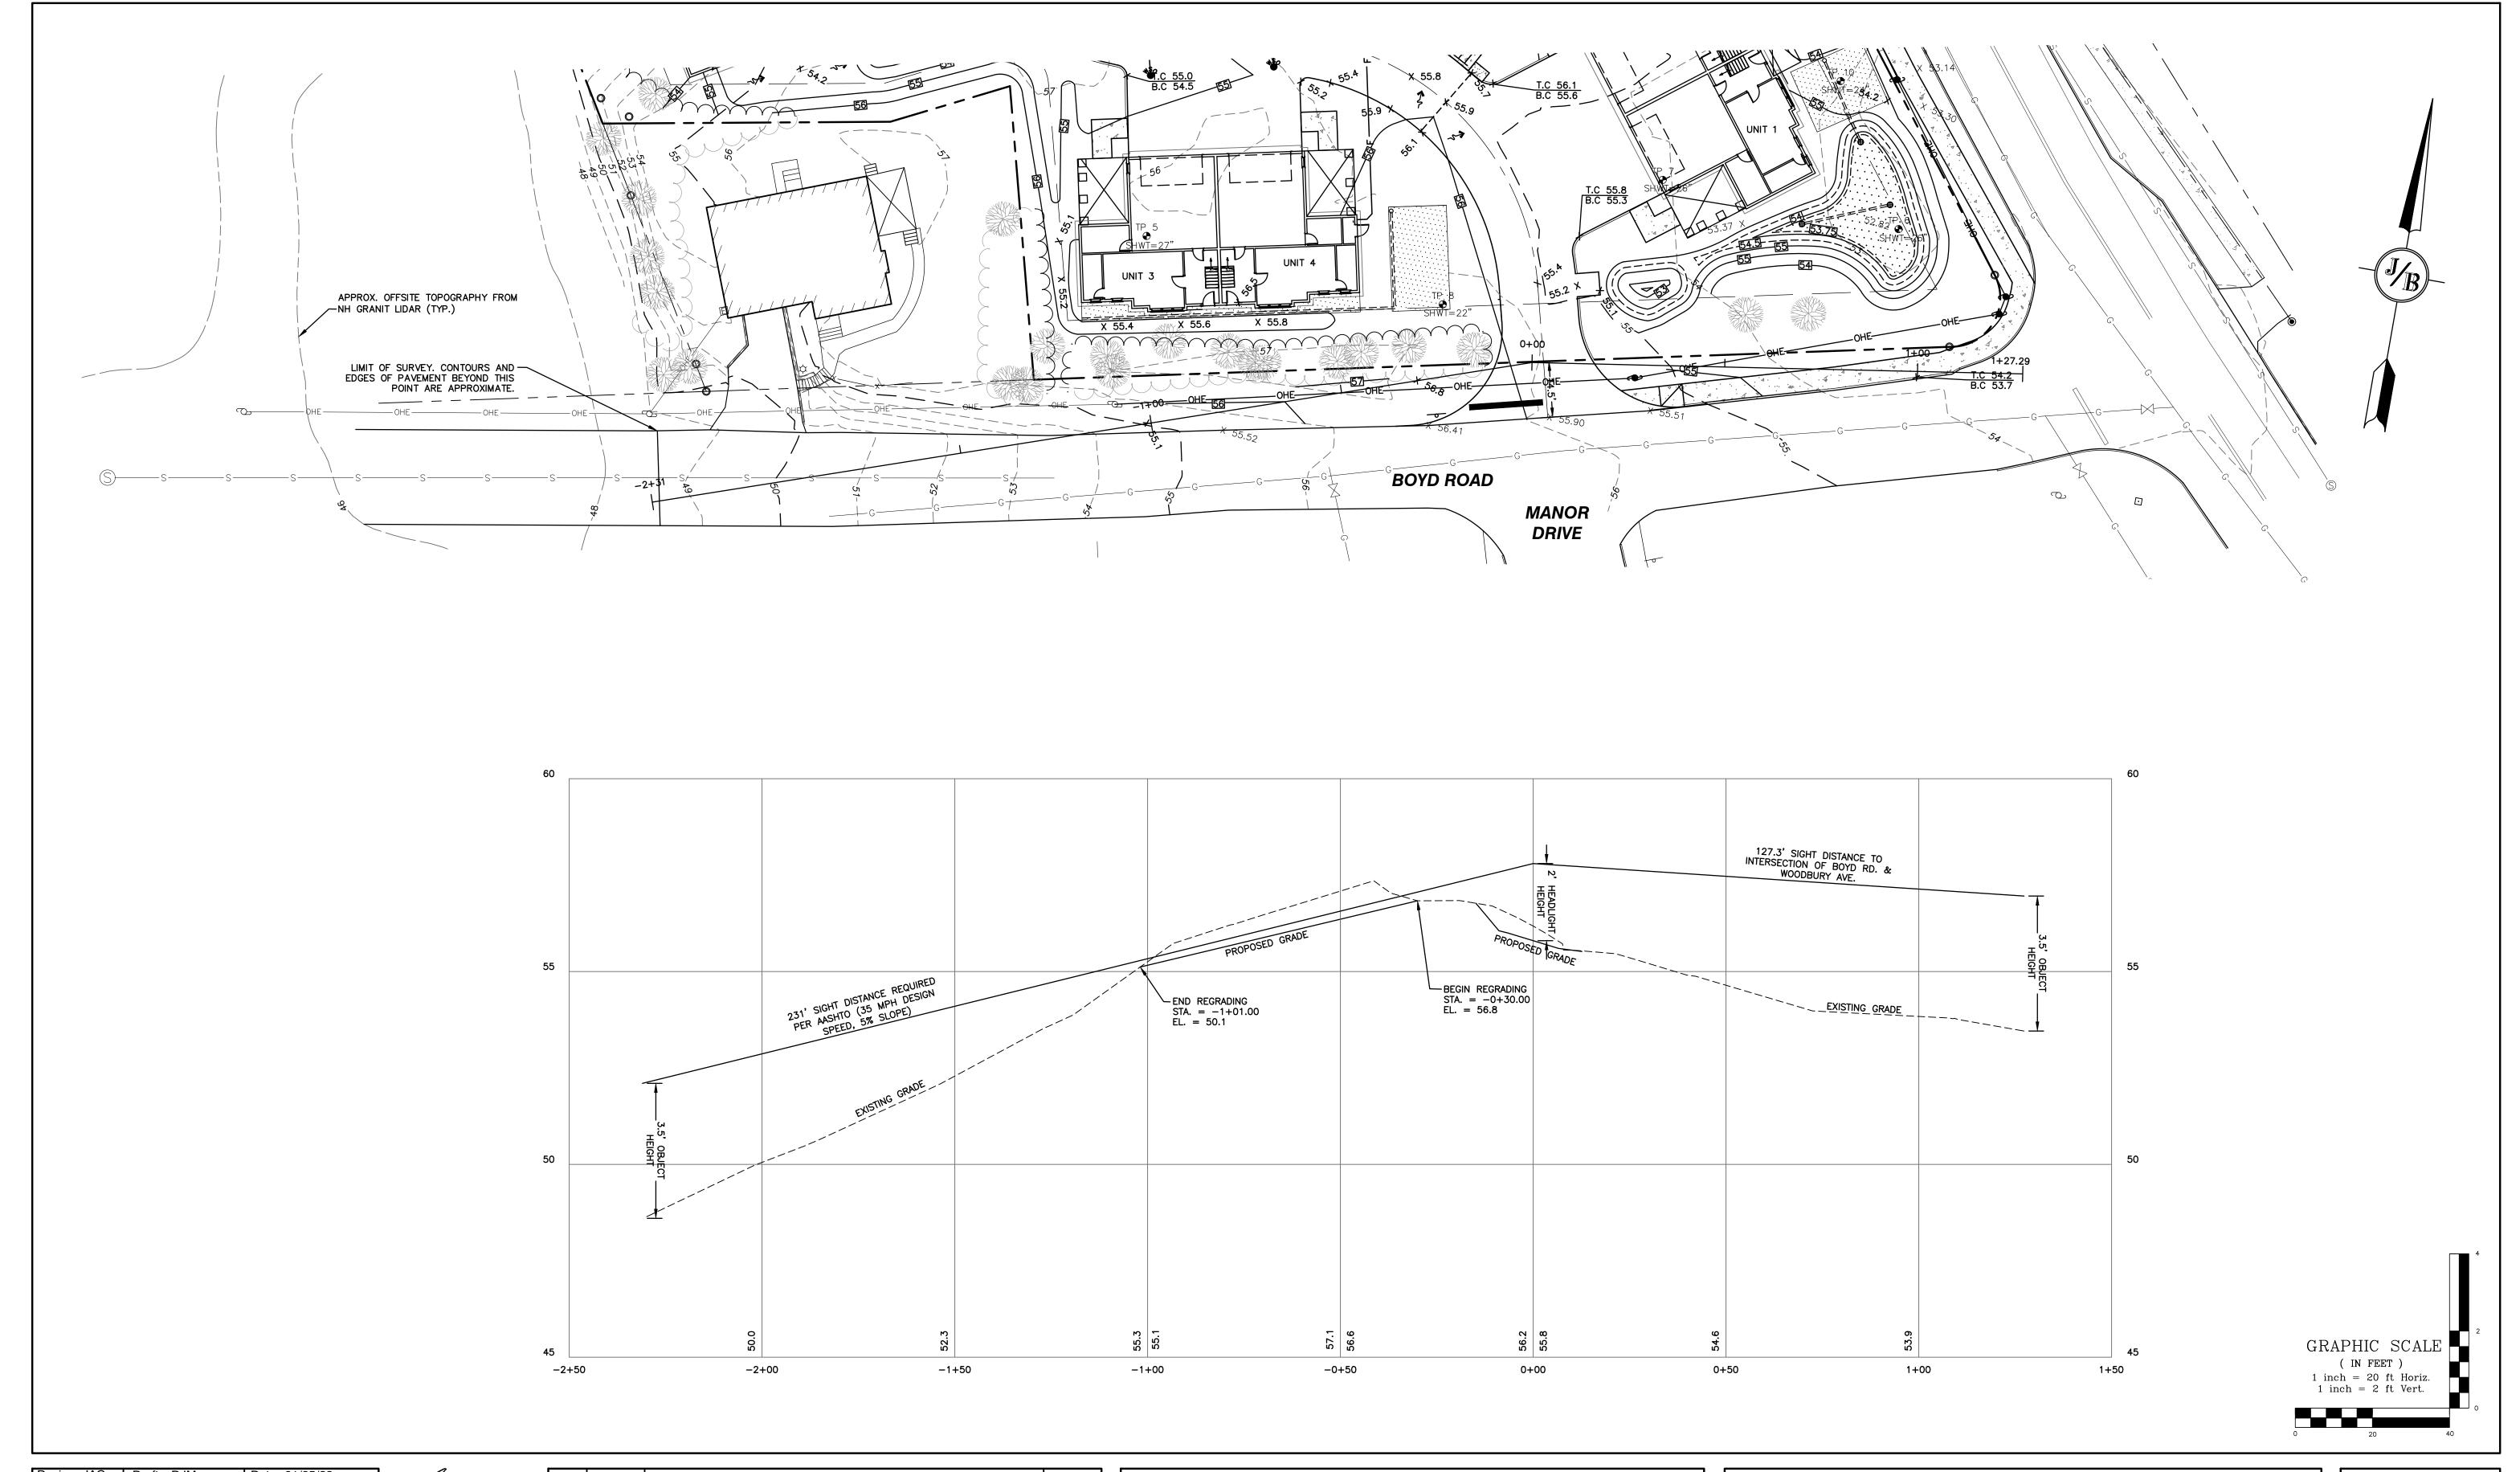
Pagineers, Inc.

85 Portsmouth Ave. Civil Engineering Services
PO Box 219
Stratham, NH 03885

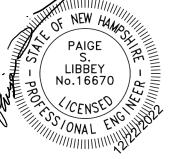Civil Engineering Services
E-MAIL: JBE@3 Services
603-772-4746
FAX: 603-772-0227
E-MAIL: JBE@JONESANDBEACH.COM

Plan Name:	TRUCK TURNING PLA	۸N
Project:	"GRAPEVINE RUN" 212, 214, & 216 WOODBURY AVE. PORTSMOUT	ΓH, NH 03801
Owners of Record:	FREDERICK J. BAILEY III & JOYCE S. NELSON 4 SHORE RD., WOLFEBORO, NH 03894	LOT 1: BK 4708 PG 979 LOT 2: BK 4582 PG 888 LOT 3: BK 3919 PG 1345

SHEET 21 OF 23 JBE PROJECT NO. 21254



Design: JAC Draft: DJM Date: 01/05/22
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Drawing Name: 21254-PLAN.dwg
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Jones & Beach Engineers, Inc.

85 Portsmouth Ave. Civil Engineering Somvious 603-772-4746

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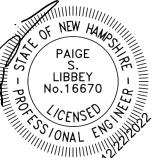
	Plan Name:	HIGHWAY ACCESS PL	AN
	Project:	"GRAPEVINE RUN" 212, 214, & 216 WOODBURY AVE. PORTSMOUT	TH, NH 03801
	Owners of Record:	FREDERICK J. BAILEY III & JOYCE S. NELSON 4 SHORE RD., WOLFEBORO, NH 03894	LOT 1: BK 4708 PG 979 LOT 2: BK 4582 PG 888 LOT 3: BK 3919 PG 1345





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"GRAPEVINE RUN" Project: 212, 214, & 216 WOODBURY AVE. PORTSMOUTH, NH 03801 LOT 1: BK 4708 PG 979 LOT 2: BK 4582 PG 888 LOT 3: BK 3919 PG 1345

Owner of Record:

FREDERICK J. BAILEY III & JOYCE S. NELSON

4 SHORE RD., WOLFEBORO, NH 03894

DR1 SHEET 23 OF 23 JBE PROJECT NO. 21254